
LOCATED IN THE SOUTHWEST 1/4 OF SECTION 1, TOWNSHIP 8 SOUTH, RANGE

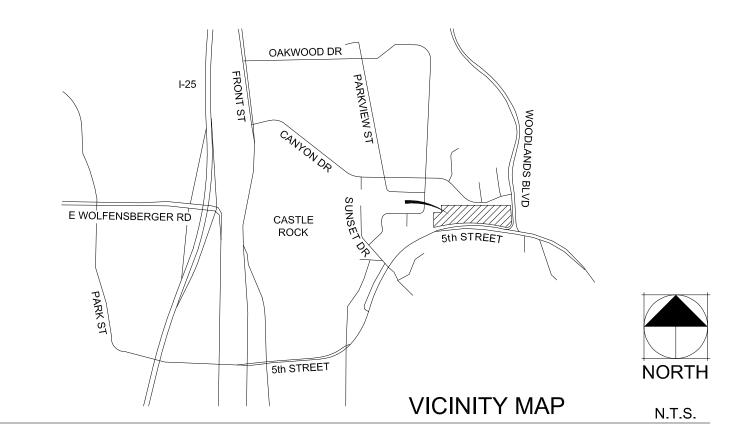

67 WEST OF THE 6TH P.M. COUNTY OF DOUGLAS, STATE OF COLORADO

LEGAL DESCRIPTION

ALL OF THOSE PROPERTIES DESCRIBED IN THE DOCUMENT RECORDED UNDER RECEPTION NO. 2016009092 IN THE RECORDS OF THE DOUGLAS COUNTY CLERK AND RECORDER, LOCATED IN THE SOUTHWEST 1/4 OF SECTION 1, TOWNSHIP 8 SOUTH, RANGE 67 WEST OF THE 6TH P.M. COUNTY OF DOUGLAS, STATE OF COLORADO, BEING MORE PARTICULARLY DESCRIBED AS FOLLOWS:

BEGINNING AT THE SOUTHWEST CORNER OF THE NORTHWEST 1/4 OF THE SOUTHWEST 1/4 OF SECTION 1, TOWNSHIP 8 SOUTH, RANGE 67 WEST OF THE 6TH P.M., SAID POINT BEING THE SOUTHWESTERLY CORNER OF THE WOODLANDS FILING NO. 8 RECORDED UNDER RECEPTION NO. 9348216 IN THE RECORDS OF THE DOUGLAS COUNTY CLERK AND RECORDER;

THENCE ON THE SOUTHERLY LINE OF SAID THE WOODLANDS FILING NO. 8, THE FOLLOWING FOUR (4) COURSES:

- 1. N88°46'20"E A DISTANCE OF 40.00 FEET;
- 2. N02°18'30"E A DISTANCE OF 75.14 FEET;
- 3. N88°46'20"E A DISTANCE OF 960.36 FEET;
- 4. S01°13'40"E A DISTANCE OF 75.00 FEET, TO THE NORTHWESTERLY CORNER OF CASTLE ROCK CHURCH OF CHRIST RECORDED UNDER

THENCE ON THE WESTERLY LINE OF SAID CASTLE ROCK CHURCH OF CHRIST, THE FOLLOWING TWO (2) COURSES:

- 1. S01°13'40"E A DISTANCE OF 160.26 FEET, TO A POINT OF CURVE;
- 2. ON THE ARC OF A NON-TANGENT CURVE TO THE RIGHT, WHOSE CENTER BEARS \$88°21'48"W, HAVING A RADIUS OF 45.00 FEET, A CENTRAL ANGLE OF 99°37'10" AND AN ARC LENGTH OF 78.24 FEET, TO A POINT OF NON-TANGENT ON THE NORTHERLY RIGHT-OF-WAY LINE OF 5TH STREET AS DESCRIBED IN THE DOCUMENT RECORDED UNDER RECEPTION NO. 2006057785;

THENCE ON SAID NORTHERLY RIGHT-OF-WAY LINE, THE FOLLOWING FOUR (4) COURSES:

- 1. N81°41'33"W A DISTANCE OF 331.83 FEET, TO A POINT OF NON-TANGENT CURVE;
- 2. ON THE ARC OF A NON-TANGENT CURVE TO THE LEFT, WHOSE CENTER BEARS \$08°15'45"W. HAVING A RADIUS OF 1333.30 FEET. A CENTRAL ANGLE OF 09°57'34" AND AN ARC LENGTH OF 231.76 FEET, TO A POINT OF NON-TANGENT;

3. S81°21'22"W A DISTANCE OF 156.86 FEET, TO A POINT OF NON-TANGENT CURVE;

4. ON THE ARC OF A NON-TANGENT CURVE TO THE LEFT, WHOSE CENTER BEARS S08°34'20"E, HAVING A RADIUS OF 1323.30 FEET, A CENTRAL ANGLE OF 10°49'25" AND AN ARC LENGTH OF 249.98 FEET, TO A POINT OF NON-TANGENT ON THE EASTERLY LINE OF A REPLAT OF LOTS 18, 19, 20 AND 21, OAKWOOD PARK, RECORDED UNDER RECEPTION NO. 313658;

THENCE ON SAID EASTERLY LINE AND THE EASTERLY LINE OF OAKWOOD PARK RECORDED UNDER RECEPTION NO. 1977204309, N00°03'54"W A DISTANCE OF 207.23 FEET, TO THE POINT OF BEGINNING.

CONTAINING A CALCULATED AREA OF 236,722 SQUARE FEET OR 5.4344 ACRES.

BASIS OF BEARING:

THE WEST LINE OF THE NORTHWEST ¼ OF THE SOUTHWEST ¼ OF SECTION 1, TOWNSHIP 8 SOUTH, RANGE 67 WEST OF THE 6TH P.M., MONUMENTED BY A 2-1/2" ALUMINUM CAP STAMPED "LS 24960" AT THE NORTH AND A 2-1/2" ALUMINUM CAP STAMPED "LS 38376" AT THE SOUTH, BEING ASSUMED TO BEAR NO2d18'30"E.

BENCHMARK

#5 REBAR W/O CAP @ SE CORNER OF LOT 1, BLOCK 3, WOODLANDS FILING NO. 8.

ZONING	COMPARISON				
ZONING	CALVARY CHAP	EL PD			
	REQUIREMENT	PROVIDED			
PERMITTED USES	CHURCH AND RELATED USES PER SECTION 'F' OF THE PD ZONING REGULATIONS	CHURCH AND RELATED OFFICE AND CLASSROOM USES			
MAX. BUILDING COVERAGE	35%	10%			
MAX. FLOOR AREA RATIO (FAR)	0.35	0.10			
MAX. SPIRE HEIGHT ABOVE BUILDING	15'	N/A			
MIN. BUFFER FROM NORTH & WEST PROP. LINE	30'	30'			
MIN. SETBACK FROM FIFTH STREET	25'	41'			
MIN. SETBACK FROM WOODLANDS BLVD.	25'	315'			
MIN. SETBACK FROM NORTH PROP. LINE	30'	67'			
MIN. SETBACK FROM WEST PROP. LINE	30'	434'			
MAX. BUILDING HEIGHT	35-FEET	33-FEET 7 INCHES AVG.			
	4 ODA OF DED 2 OF A TO IN THE	PROVIDED= 253			
MINIMUM PARKING	1 SPACE PER 3 SEATS IN THE SANCTUARY	SANCTUARY SEATS=758 (758/3 =253)			
MINIMUM ADA PARKING	PER MUNI. CODE 7 ADA SPACES REQUIRED FOR 201 TO 300 TOTAL LOT SPACES	PROVIDED = 8 TOTAL LOT SPACES=253			
SITE UTILIZATION					
	S.F.	% OF TOTAL			
BUILDING COVERAGE	22,788	9.6%			
PARKING COVERAGE	99,189	41.9%			
SIDEWALK COVERAGE	10,855	4.6%			
LANDSCAPE/ OPEN SPACE COVERAGE	103,890	43.9%			
TOTAL	236,722	100%			

OWNERSHIP CERTIFICATION

THE UNDERSIGNED ARE ALL THE OWNERS OF CERTAIN LANDS IN THE TOWN OF CASTLE ROCK, COUNTY OF DOUGLAS AND STATE OF COLORADO DESCRIBED HEREIN.

CALVARY CHAPEL, CASTLE ROCK, A COLORADO NON-PROFIT CORPOR	ATION		
NOTARY BLOCK			
SUBSCRIBED AND SWORN TO BEFO	RE ME THIS	DAY OF	, 20
BYOF CALVARY CHAPEL. CASTLE ROCK	_AS		

NOTARY PUBLIC MY COMMISSION EXPIRES:

PLANNING COMMISSION RECOMMENDATION

THIS SITE DEVELOPMENT PLAN WAS RECOMMENDED FOR APPROVAL BY THE PLANNING COMMISSION OF THE TOWN OF CASTLE ROCK, COLORADO

CHAIR	DATE
ATTEST:	
DIRECTOR OF DEVELOPMENT SERVICES	DATE

ON THE _____ DAY OF ________, 20_____.

TOWN COUNCIL APPROVAL

TOWN CLERK

THIS SITE DEVELOPMENT PLAN WAS APPROVED BY THE TOWN COUNCIL OF THE TOWN OF CASTLE ROCK, COLORADO,

ON THEDAY OF	, 20
MAYOR	DATE
ATTEST:	

CLERK AND RECORDER CERTIFICATE

STATE OF COLORADO) COUNTY OF DOUGLAS) I HEREBY CERTIFY THAT THIS SITE DEVELOPMENT PLAN WAS FILED FOR RECORD IN MY OFFICE AT ______ O'CLOCK ____. M., __, 20____, A.D., AND IS DULY RECORDED UNDER RECEPTION NUMBER

OF THE RECORDS OF DOUGLAS COUNTY, COLORADO. DOUGLAS COUNTY CLERK AND RECORDER

CIVIL ENGINEER'S CERTIFICATE

BEING A REGISTERED PROFESSIONAL ENGINEER IN THE STATE OF COLORADO, HEREBY ATTEST THAT ALL GRADING, UTILITY AND DRAINAGE IMPROVEMENTS IDENTIFIED ON THIS SITE DEVELOPMENT PLAN HAVE BEEN DESIGNATED AND ENGINEERED IN CONFORMANCE WITH ALL TOWN OF CASTLE ROCK PUBLIC WORKS CONSTRUCTION

REGISTERED PROFESSIONAL ENGINEER	DATE	

REGISTRATION NUMBER

TITLE CERTIFICATION

, AN AUTHORIZED REPRESENTATIVE OF , A TITLE INSURANCE COMPANY LICENSED TO DO BUSINESS IN THE STATE OF COLORADO, HAVE MADE AN EXAMINATION OF THE PUBLIC RECORDS AND STATE THAT ALL OWNERS, MORTGAGEES AND LIENHOLDERS OF THE PROPERTY ARE LISTED IN THE CERTIFICATE OF OWNERSHIP AND LIENHOLDER SUBORDINATION CERTIFICATE.

AUTHORIZED REPRESENTATIVE	_
TITLE COMPANY	_
SIGNED THIS DAY OF	, 20
NOTARY BLOCK	

SUBSCRIBED AND SWORN TO BEFORE ME THIS _____ DAY OF ____

20_____ BY _____ AS AUTHORIZED REPRESENTATIVE

WITNESS MY HAND AND OFFICIAL SEAL. NOTARY PUBLIC

MY COMMISSION EXPIRES: _____

SURVEYOR'S CERTIFICATE

AGENCIES

OWNER/DEVELOPER:

LAND PLANNER /

PLAN PREPARER:

ENGINEER/SURVEYOR:

TOWN OF CASTLE ROCK:

CALVARY CHAPEL 1100 CAPRICE DR

P~303.663.2514

702 N. TEJON ST

P~719.578.8777

JR ENGINEERING

P~303.267.6241

P~719.577.4500

100 WILCOX ST. CASTLE ROCK, CO 80104

P~720-733-3511

P~720-733-2462

P~720-733-6000

PUBLIC WORKS DEPT.

4175 CASTLETON CT. CASTLE ROCK, CO 80109

UTILITY DEPARTMENT 175 KELLOGG CT. CASTLE ROCK, CO 80109

104 S. CASCADE AVE.

MORTGAGEES/LIENHOLDER: COLORADO EAST BANK & TRUST

CASTLE ROCK, CO. 80109

THOMAS AND THOMAS

COLORADO SPRINGS, CO 80903

3730 SINTON ROAD, SUITE 219 COLORADO SPRINGS, CO 80907

COLORADO SPRINGS, CO 80903

DEVELOPMENT SERVICES DEPARTMENT

, A REGISTERED PROFESSIONAL LAND SURVEYOR IN THE STATE OF COLORADO, DO HEREBY CERTIFY THAT THE SURVEY AND LEGAL DESCRIPTION REPRESENTED BY THIS SITE DEVELOPMENT PLAN WAS MADE UNDER MY SUPERVISION AND THE MONUMENTS SHOWN THEREON ACTUALLY EXIST AND THIS SITE DEVELOPMENT PLAN ACCURATELY REPRESENTS THAT

REGISTERED LAND SURVEYOR	DATE

REGISTRATION NUMBER

LIENHOLDER SUBORDINATION CERTIFICATE

THE UNDERSIGNED ARE ALL THE MORTGAGEES AND LIENHOLDERS OF CERTAIN LANDS IN THE TOWN OF CASTLE ROCK, COUNTY OF DOUGLAS AND STATE OF COLORADO DESCRIBED HEREON. THE UNDERSIGNED BENEFICIARY OF THE LIEN CREATED BY THE INSTRUMENT RECORDED FEBRUARY 17, 2016 AT RECEPTION NO.

DOUGLAS COUNTY, COLORADO, SUBORDINATES THE SUBJECT LIEN TO THE TERMS, CONDITIONS AND RESTRICTIONS OF THIS DOCUMENT.

COLORADO EAST BANK & TRUST	

NOTARY BLOCK

SUBSCRIBED AND SWORN TO BEFORE ME

THIS DAY OF

WITNESS MY HAND AND OFFICIAL SEAL.

MY COMMISSION EXPIRES:

NOTARY PUBLIC

SHEET INDEX


COVER SHEET NOTES & DETAILS SITE DEVELOPMENT PLAN GENERAL GRADING PLAN GENERAL UTILITIES PLAN

6-9 GENERAL RETAINING WALL DETAILS 10 LANDSCAPE DATA CONCEPTUAL LANDSCAPE PLAN

12 EXTERIOR ELEVATIONS 13 ELECTRICAL SITE PLAN


14 PHOTOMETRIC SITE PLAN

CALVARY CHAPEL SITE DEVELOPMENT PLAN PROJECT NO. SDP16-0031

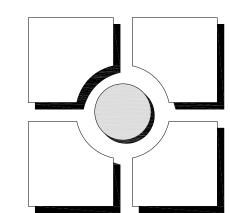


S

# >	REVISIONS	DATE	DRAWN	DRAWN CHECKED APPRO	APPRO
\vdash	TOWN REVISIONS REV 2	07/19/17			
2	2 TOWN REVISIONS REV. 3	9/28/17			
က	TOWN REVISIONS REV. 4	11/2/17			
4	TOWN REVISIONS REV. 5	2/2/18			
5	TOWN REVISIONS REV. 6/7	3/30/18			
9	TOWN REVISIONS REV. 8	4/18/18			

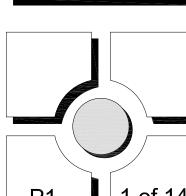

LOCATED IN THE SOUTHWEST 1/4 OF SECTION 1, TOWNSHIP 8 SOUTH, RANGE 67 WEST OF THE 6TH P.M. COUNTY OF DOUGLAS, STATE OF COLORADO

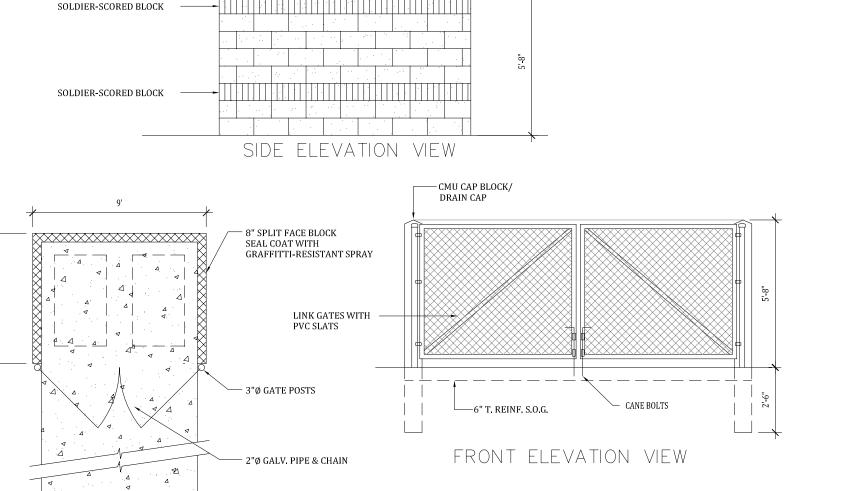

CMU TRASH ENCLOSURE DETAIL

SAFE USE ZONE BORDER TIMBERFORM PLAY EQUIPMENT MODEL NO. 4805-TF ACCESSIBLE ENTRANCE DECK ARCH RING CLIMBER BALUSTER WALL WITH SHIP'S WHEEL **BUBBLE PANEL** COIL CLIMBER PERFORATED STEEL ROOF SLIDE CHUTE, CURVED SPELLING PANEL STEPPING PAD (5) TIC-TAC-TOE ACCESSIBILITY PROFILE: 9 TOTAL PLAY COMPONENTS **5 ELEVATED PLAY COMPONENTS** (5 ACCESSIBLE) 4 GROUND LEVEL PLAY COMPONENTS (4 ACCESSIBLE) PLAY AREA, EQUIPMENT ONLY: 16' x 17' MINIMUM SAFE USE ZONE: 28' x 29'



5

PLAY AREA: PLAY STRUCTURE

5 PLAY ARI

Standard
Leaf Widths

Post size varies with Height

Height

Conc. Footer Per
MANUFACTURER'S
SPECIFICATIONS

PLAY AREA ORNAMENTAL FENCE

CMU CAP BLOCK/

PLAN VIEW

6' MAX. SPACING
(TYP. OF ALL RAILS)


TOP OF WALL


EMBED POST
12" MIN.

RETAINING WALL

NOTE: STEEL SHALL BE ASTM A 53 TYPES E OR S, GRADE A, BLACK. GRIND ALL WELDS SMOOTH.



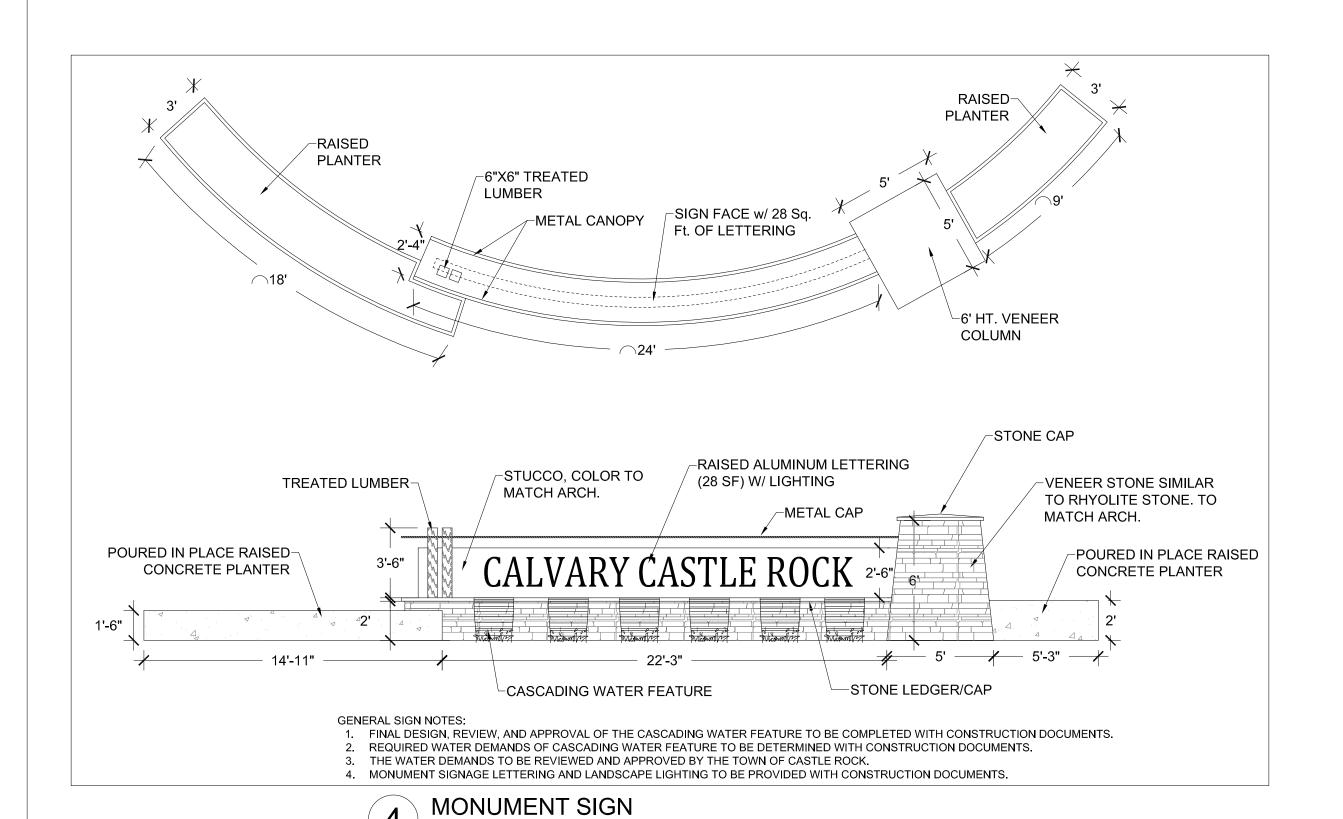

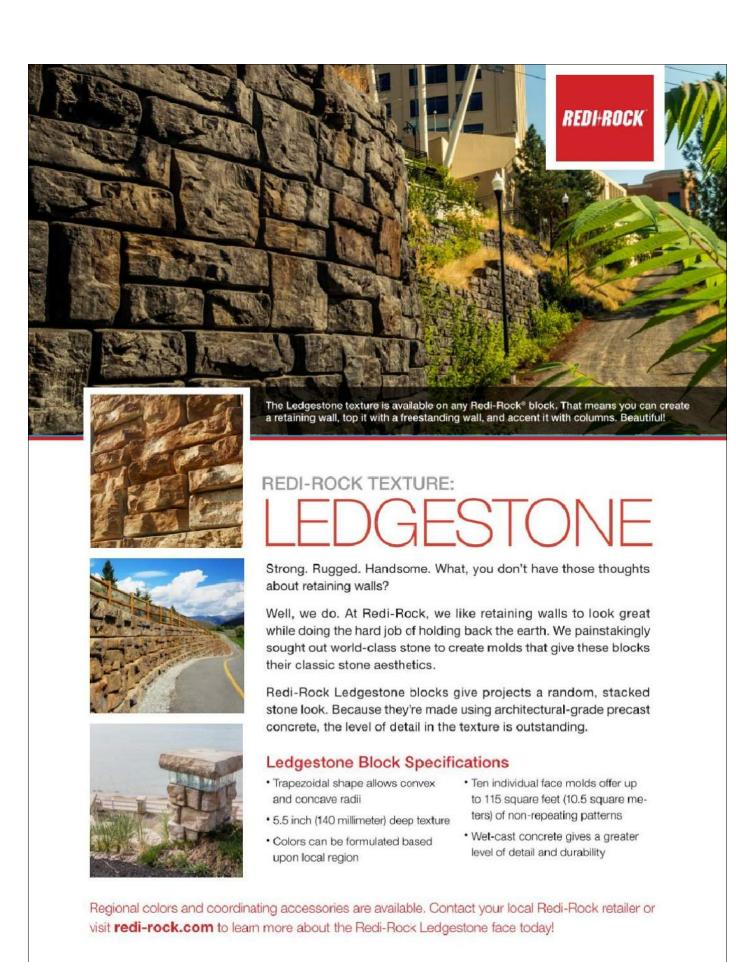

RETAINING WALL GENERAL NOTE:

1. RETAINING WALL TO BE REDI-ROCK LEDGESTONE TEXTURE, COLOR TO BE TAN.



SITE DEVELOPMENT PLAN GENERAL NOTES

- 1. THE TOWN OF CASTLE ROCK REQUIRES THAT MAINTENANCE ACCESS BE PROVIDED TO ALL STORM DRAINAGE FACILITIES TO ASSURE CONTINUOUS OPERATIONAL CAPABILITY OF THE SYSTEM. THE PROPERTY OWNER, SUBSEQUENT OWNERS, HEIRS, SUCCESSORS AND ASSIGNS SHALL BE RESPONSIBLE FOR THE MAINTENANCE OF ALL DRAINAGE FACILITIES INCLUDING, BUT NOT LIMITED TO, INLETS, PIPES, CULVERTS, CHANNELS, DITCHES, HYDRAULIC STRUCTURES, AND DETENTION BASINS LOCATED ON THIS PROPERTY, UNLESS MODIFIED BY THE SUBDIVISION IMPROVEMENTS AGREEMENT. SHOULD THE OWNER FAIL TO ADEQUATELY MAINTAIN SAID FACILITIES, THE TOWN SHALL HAVE THE RIGHT TO ENTER SAID PROPERTY FOR THE PURPOSES OF OPERATION AND MAINTENANCE. ALL SUCH MAINTENANCE COSTS WILL BE ASSESSED TO THE PROPERTY OWNER, SUBSEQUENT OWNERS, HEIRS, SUCCESSORS AND ASSIGNS. THE MAINTENANCE COSTS SHALL INCLUDE ALL ACTUAL COSTS FOR LABOR, EQUIPMENT AND MATERIALS AND A 25% FEE.
- PURSUANT TO SECTION 4.3E AND 8.2.3A OF THE TOWN OF CASTLE ROCK LANDSCAPE REGULATIONS THE PROPERTY OWNER, SUBSEQUENT OWNERS, HEIRS, SUCCESSORS AND ASSIGNS SHALL BE RESPONSIBLE FOR THE PROPER MAINTENANCE OF THE AREA SUBJECT TO THE APPROVED SITE DEVELOPMENT PLAN. LANDSCAPING WITHIN PUBLIC RIGHTS-OF-WAY IS TO BE MAINTAINED BY THE ADJACENT PRIVATE PROPERTY OWNER OR THE HOMEOWNER/PROPERTY OWNER ASSOCIATION, AS APPLICABLE. LANDSCAPING SHALL BE CONTINUOUSLY MAINTAINED INCLUDING NECESSARY WATERING, WEEDING, PRUNING, MOWING, PEST CONTROL, AND REPLACEMENT OF DEAD OR DISEASED PLANT MATERIAL. UPON WRITTEN NOTICE BY THE TOWN, THE OWNER WILL HAVE 45 DAYS TO CURE OR REPLACE DAMAGED OR DEAD LANDSCAPE MATERIAL. IN THE CASE OF DISEASED LANDSCAPE MATERIAL, A SHORTER COMPLIANCE PERIOD MAY BE SPECIFIED IN SAID NOTICE. THE TOWN OF CASTLE ROCK WATER CONSERVATION ORDINANCE REGULATES TIMES OF SEASONAL IRRIGATION AND PROHIBITS THE WASTING OF POTABLE WATER THROUGH IMPROPER IRRIGATION.
 THE LANDSCAPE AND IRRIGATION PLANS CONTAINED IN THE SITE DEVELOPMENT PLAN ARE CONCEPTUAL ONLY AND SUBJECT TO

CHANGE WITH REVIEW OF THE CONSTRUCTION DOCUMENTS.

4. THE PROJECT SITE IS NOT LOCATED WITHIN A DESIGNATED FEMA FLOODPLAIN AS DETERMINED BY THE FLOOD INSURANCE RATE

MAP, COMMUNITY MAP NUMBER '08035C0188G', REVISED MARCH 16, 2016.

5. ANY STREET SIGNS, STRIPING, STREET LIGHTS AND CURB RAMPS ARE CONCEPTUAL ONLY AND SUBJECT TO TOWN REVIEW WITH THE CONSTRUCTION DOCUMENTS. THESE ITEMS SHALL COMPLY WITH THE TOWN OF CASTLE ROCK'S REGULATIONS, STANDARDS AND REQUIREMENTS.

6. THE DEVELOPER SHALL CONFORM TO THE TOWN OF CASTLE ROCK "WATER USE MANAGEMENT PROGRAM IMPLEMENTATION POLICY", AS AMENDED FROM TIME TO TIME, FOR THIS PROJECT.

7. APPROVAL OF THIS CONCEPTUAL SITE DEVELOPMENT PLAN DOES NOT CONSTITUTE APPROVAL OF ANY DEVIATIONS FROM TOWN OF CASTLE ROCK REGULATIONS AND STANDARDS. ALL DEVIATIONS FROM TOWN REGULATIONS AND STANDARDS ARE SUBJECT TO

THE APPROPRIATE PROCEDURES FOR APPROVAL.

8. NO SOLID OBJECT (EXCLUDING FIRE HYDRANTS, TRAFFIC CONTROL DEVICES AND TRAFFIC SIGNS) EXCEEDING THIRTY (30) INCHES IN HEIGHT ABOVE THE FLOWLINE ELEVATIONS OF THE ADJACENT STREET, INCLUDING BUT NOT LIMITED TO BUILDINGS, UTILITY CABINETS, WALLS, FENCES, LANDSCAPE PLANTINGS, CROPS, CUT SLOPES, AND BERMS SHALL BE PLACED WITHIN SIGHT DISTANCE LINES AND SIGHT DISTANCE EASEMENTS.

9. ALL UTILITY, DRAINAGE, EMERGENCY ACCESS, SIGHT DISTANCE AND PUBLIC ACCESS/TRAIL EASEMENTS AS SHOWN ON THE SITE DEVELOPMENT PLAN SHALL BE GRANTED TO THE TOWN OF CASTLE ROCK WITH THE PLAT.

10. THIS SITE IS ZONED (PD) PLANNED DEVELOPMENT.

11. UNLESS OTHERWISE NOTED, ALL LOTS SHALL HAVE A 10-FOOT UTILITY EASEMENT ALONG THE FRONT AND REAR LOT LINES AND ALONG ALL PUBLIC RIGHTS-OF-WAY AND SHALL HAVE 5-FOOT UTILITY EASEMENTS ALONG EACH SIDE LOT LINE. THESE UTILITY EASEMENTS ARE FOR THE INSTALLATION, MAINTENANCE AND OPERATION OF UTILITIES AND DRAINAGE FACILITIES INCLUDING, BUT NOT LIMITED TO STREET LIGHTS, ELECTRIC LINES, GAS LINES, CABLE TELEVISION LINES, FIBER OPTIC LINES AND TELEPHONE LINES, AS WELL AS PERPETUAL RIGHT FOR INGRESS AND EGRESS FOR INSTALLATION, MAINTENANCE AND REPLACEMENT OF SUCH LINES.

AS WELL AS PERPETUAL RIGHT FOR INGRESS AND EGRESS FOR INSTALLATION, MAINTENANCE AND REPLACEMENT OF SUCH LINES

12. RETAINING WALLS, SECTIONS OF RETAINING WALLS 4-FEET IN HEIGHT OR HIGHER OR TIERED WALLS MUST BE DESIGNED BY A

STRUCTURAL ENGINEER LICENSED IN THE STATE OF COLORADO AND MUST RECEIVE A BUILDING PERMIT FROM THE TOWN OF

CASTLE ROCK PRIOR TO THE ISSUANCE OF THE PUBLIC WORKS PERMIT.

13. A SIGN PERMIT FOR EACH SIGN MUST BE OBTAINED FROM THE TOWN OF CASTLE ROCK BUILDING DIVISION PRIOR TO PLACING ANY

SIGN ON THE PROPERTY. ALL SIGNS MUST COMPLY WITH THE PROVISIONS OF TITLE 19 (SIGN CODE REGULATIONS) OF THE MUNICIPAL CODE.

14. ALL EXISTING SCRUB OAK SHOWN TO REMAIN ON THE DRAWINGS SHALL BE PROTECTED DURING CONSTRUCTION.

FIRE NOTES

- 1. IF FIRE APPARATUS ACCESS ROADS OR WATER SUPPLY FOR FIRE PROTECTION IS REQUIRED TO BE INSTALLED, SUCH PROTECTION SHALL BE INSTALLED AND MADE SERVICEABLE PRIOR TO VERTICAL CONSTRUCTION.
- 2. FIRE HYDRANT(S) ARE REQUIRED TO BE INSTALLED AND MADE SERVICEABLE PRIOR TO AND DURING THE TIME OF CONSTRUCTION.
 3. APPROVED FIRE APPARATUS ACCESS ROADS SHALL BE PROVIDED FOR EVERY FACILITY, BUILDING OR PORTION OF A BUILDING CONSTRUCTED OR MOVED INTO, OR WITHIN THE JURISDICTION. THE FIRE APPARATUS ACCESS ROAD SHALL EXTEND TO WITHIN 150 FEET OF ALL PORTIONS OF THE FACILITY AND ALL PORTIONS OF THE EXTERIOR WALLS OF THE FIRST STORY OF THE BUILDING AS MEASURED BY AN APPROVED ROUTE AROUND THE EXTERIOR OF THE BUILDING OR FACILITY.
- 4. DEAD-END FIRE ACCESS ROADS IN EXCESS OF 150 FEET SHALL PROVIDE AN APPROVED AREA FOR TURNING AROUND FIRE APPARATUS.
 5. FIRE APPARATUS ACCESS ROADS SHALL HAVE AN UNOBSTRUCTED WIDTH OF NOT LESS THAN 20 FEET, EXCLUSIVE OF SHOULDERS, EXCEPT FOR APPROVED SECURITY GATES AND AN UNOBSTRUCTED VERTICAL CLEARANCE OF NOT LESS THAN 13 FEET, 6 INCHES.
 6. FIRE APPARATUS ACCESS ROADS SHALL BE DESIGNED AND MAINTAINED TO SUPPORT THE IMPOSED LOADS OF FIRE APPARATUS WEIGHING AT LEAST 75,000 POUNDS, AND SHALL BE SURFACED SO AS TO PROVIDE ALL-WEATHER DRIVING CAPABILITIES. THE
- TERM "ALL-WEATHER DRIVING CAPABILITIES" HAS BEEN INTERPRETED TO MEAN EITHER CONCRETE REVISED: 11/4/2014 OR ASPHALT, OR OTHER APPROVED DRIVING SURFACE DESIGNED BY AN ENGINEER AND APPROVED BY THE FIRE DEPARTMENT.

 7. "NO PARKING FIRE LANE" SIGNS ARE REQUIRED IN AREAS THAT MEET THE FOLLOWING CRITERIA AND IN AREAS DESIGNATED BY THE FIRE PREVENTION BUREAU. SIGNS SHALL BE POSTED ON BOTH SIDES OF FIRE ACCESS ROADWAYS, PUBLIC OR PRIVATE ROADWAYS AND DRIVEWAYS LESS THAN 26 FEET WIDE. SIGNS SHALL BE POSTED ON ONE SIDE ONLY OF FIRE ACCESS ROADWAYS, PUBLIC OR PRIVATE ROADWAYS OR DRIVEWAYS BETWEEN 26 FEET WIDE AND 32 FEET WIDE. NO SIGNAGE IS REQUIRED FOR FIRE ACCESS
- ROADWAYS, PUBLIC OR PRIVATE ROADWAYS OR DRIVEWAYS GREATER THAN OR EQUAL TO 32 FEET WIDE.


 8. IT IS THE RESPONSIBILITY OF THE PROPERTY OWNER TO MAINTAIN DRIVE LANES FOR EMERGENCY VEHICLE INGRESS AND EGRESS, INCLUDING SNOW REMOVAL.


DMAS THOMAS
Planning
Urban Design
Landscape Architecture
702 North Tejon
olorado Springs, Colorado 80903


SNOI	DATE	DRAWN	DRAWN CHECKED	APPROVED	
:V 2	07/19/17				
EV. 3	9/28/17				
EV. 4	11/2/17				
EV. 5	2/2/18				
57. 6/7	3/30/18				
S. V.	4/18/18				

		1
DRAWN .	JLK	07.20.16
СНЕСКЕD	JRA	07.20.16
PROJECT NUMBER:	3ER:	3539.00
SCALE:		AS NOTED

TES & DETAILS

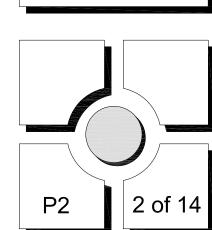

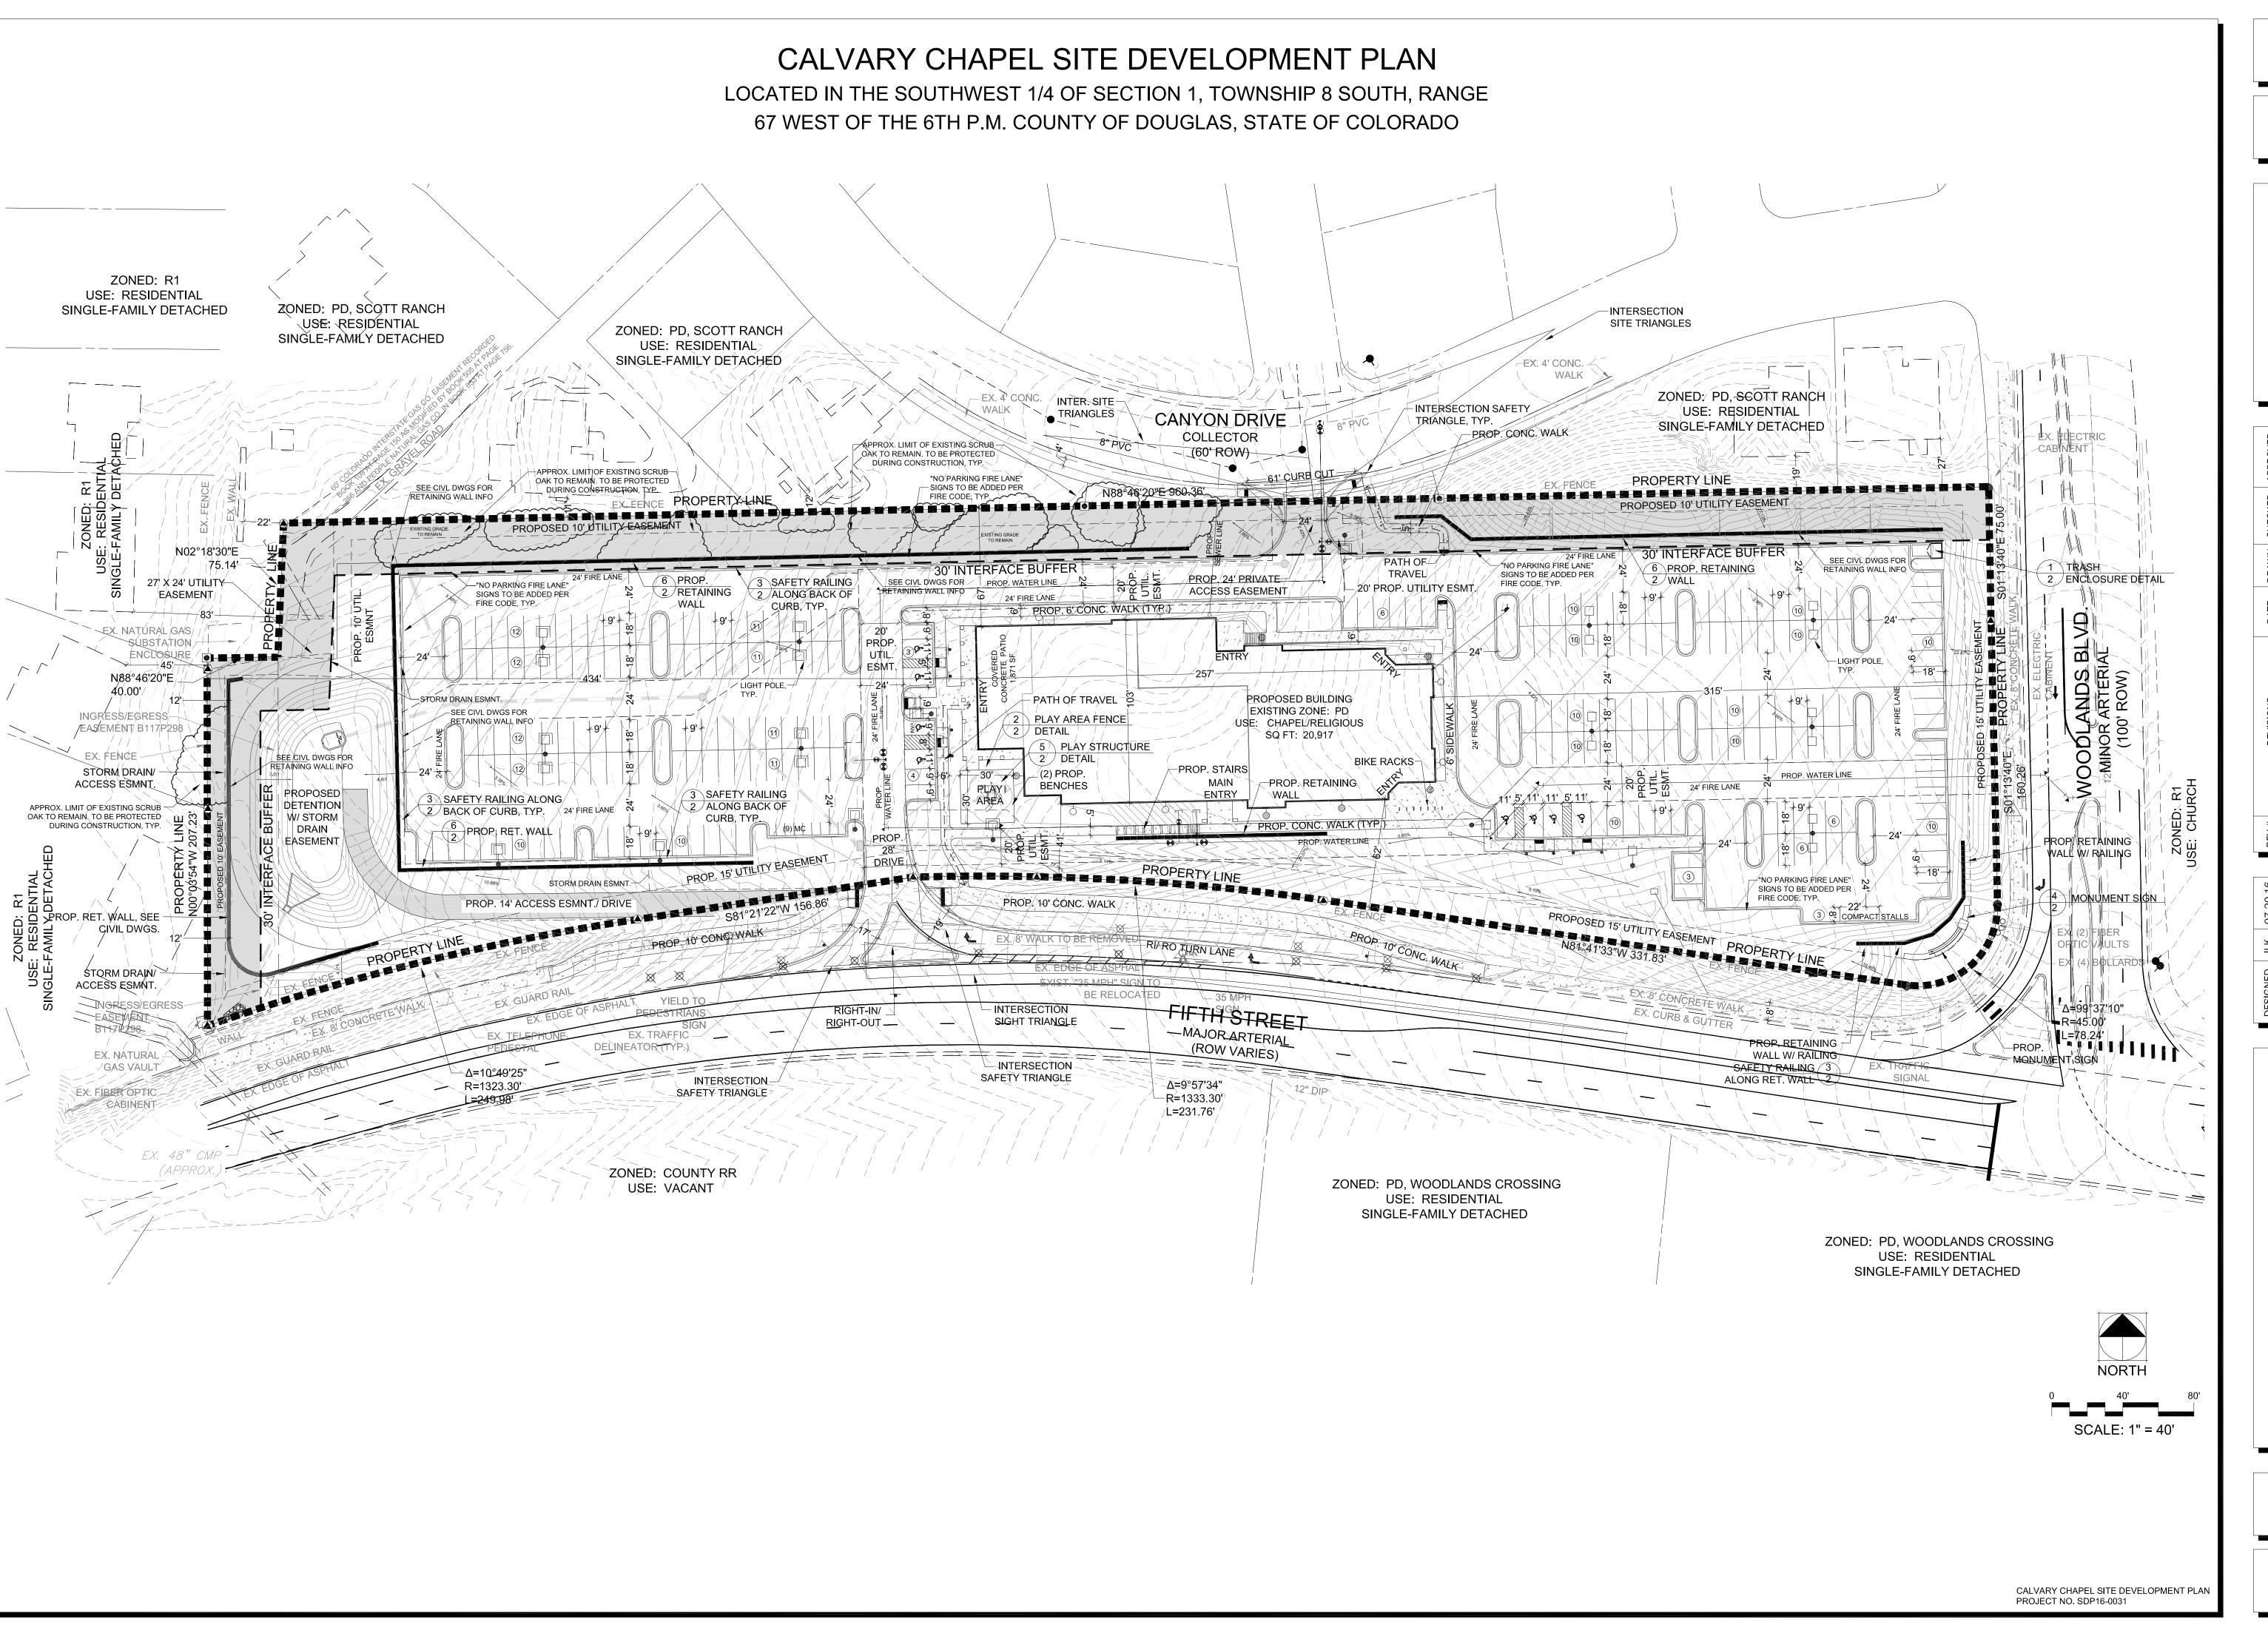


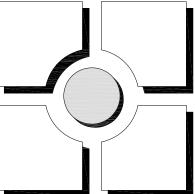


S

07/19/17	9/28/17	11/2/17	2/2/18	3/30/18	4/18/18
TOWN REVISIONS REV 2	TOWN REVISIONS REV. 3	TOWN REVISIONS REV. 4	TOWN REVISIONS REV. 5	TOWN REVISIONS REV. 6/7	TOWN REVISIONS REV. 8
1	2	က	4	2	9
16	16	3			TED
	1 TOWN REVISIONS REV 2	1 TOWN REVISIONS REV 2 2 TOWN REVISIONS REV. 3	1 TOWN REVISIONS REV 2 2 TOWN REVISIONS REV. 3 3 TOWN REVISIONS REV. 4	1 TOWN REVISIONS REV 2 2 TOWN REVISIONS REV. 3 3 TOWN REVISIONS REV. 4 4 TOWN REVISIONS REV. 5	1 TOWN REVISIONS REV 2 2 TOWN REVISIONS REV. 3 3 TOWN REVISIONS REV. 4 4 TOWN REVISIONS REV. 5 5 TOWN REVISIONS REV. 6/7

_	,			
		DESIGNED	JLK	07.20.16
		DRAWN	JLK	07.20.16
		СНЕСКЕD	JRA	07.20.16
		PROJECT NUMBER:	1BER:	3539.00

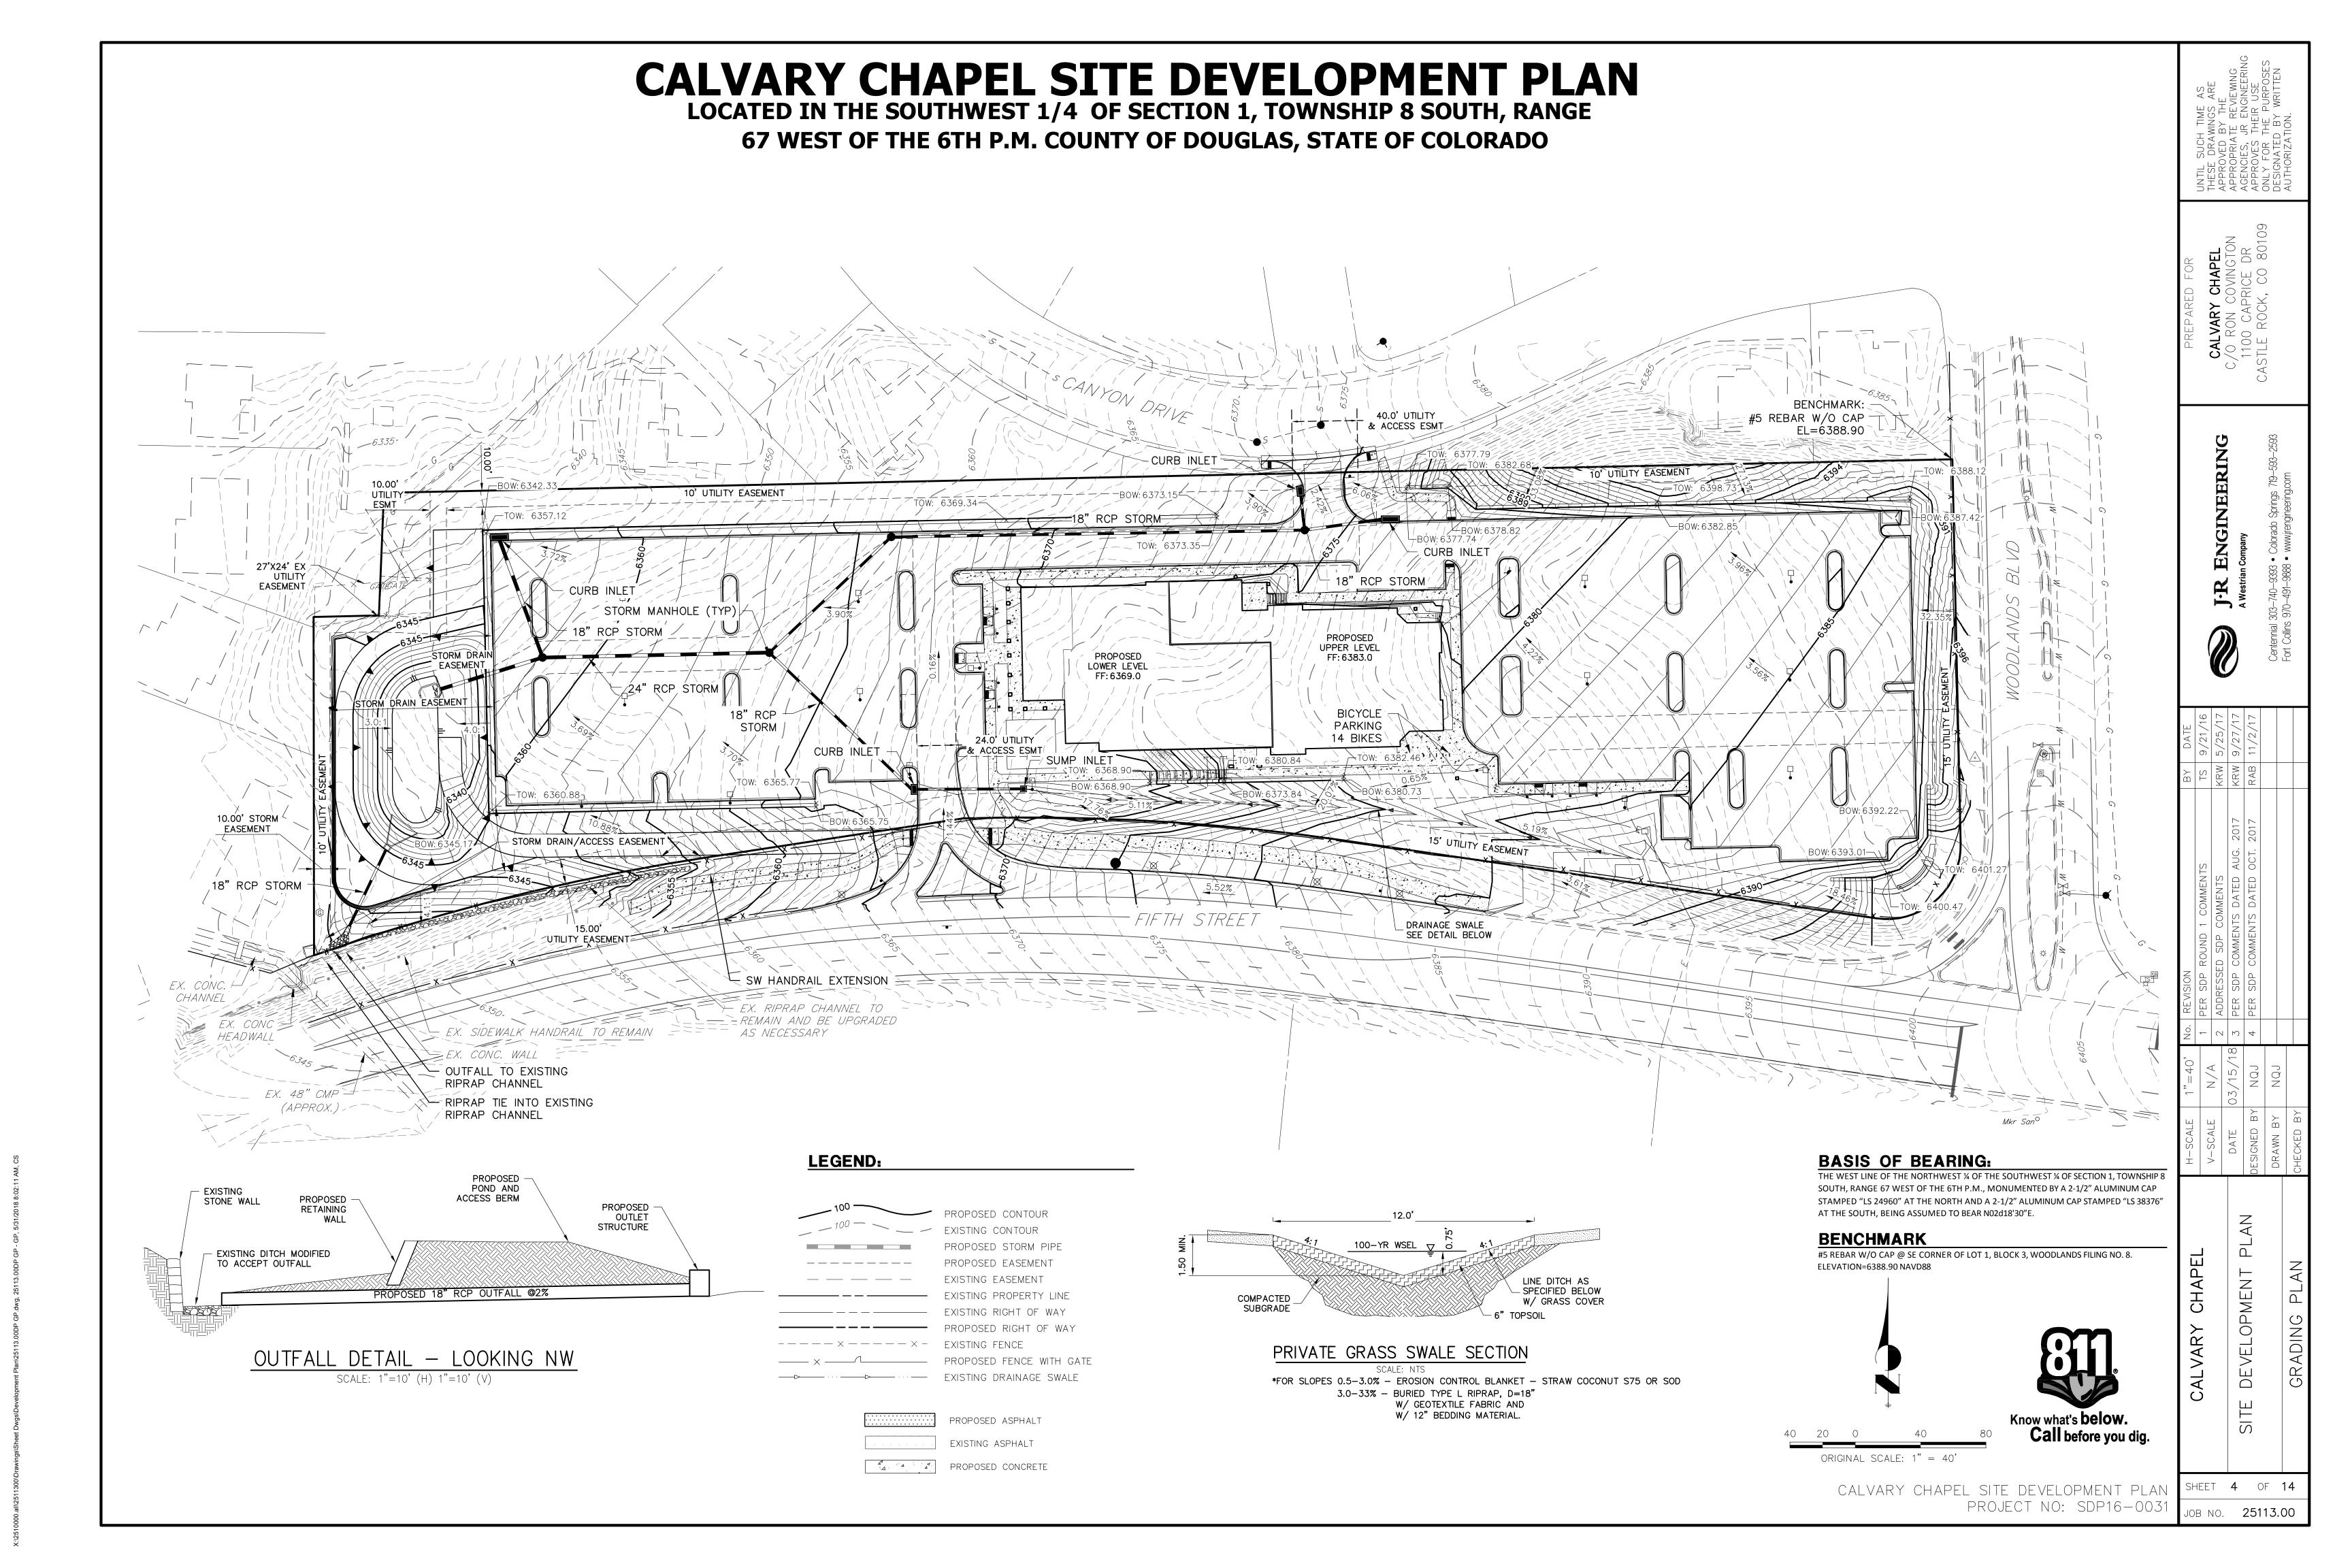

LOCATED IN THE SOUTHWEST 1/4 OF SECTION 1, TOWNSHIP 8 SOUTH, RANGE 67 WEST OF THE 6TH P.M. COUNTY OF DOUGLAS, STATE OF COLORADO

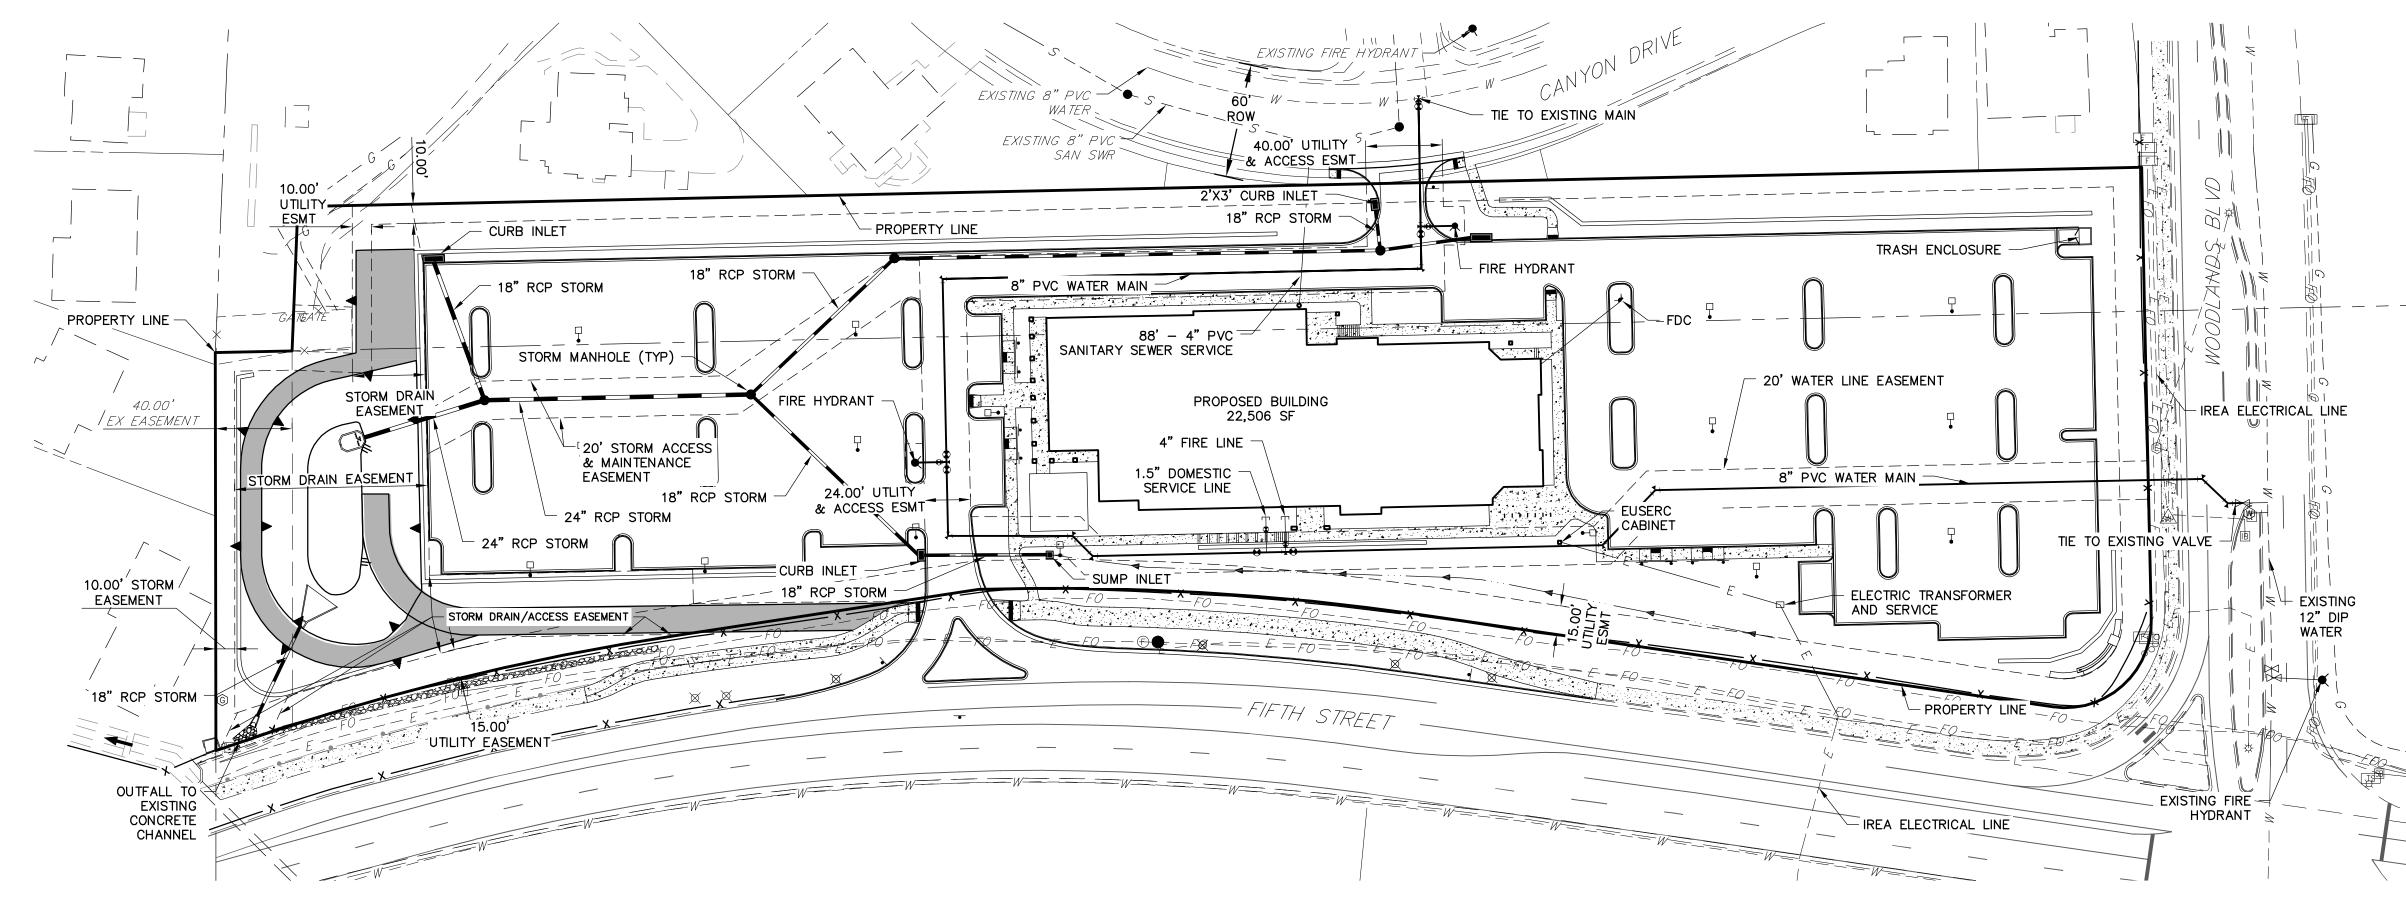

PROPOSED -

POND AND

PROPOSED -

STRUCTURE

OUTLET

ACCESS BERM

PROPOSED 18" RCP OUTFALL @2%

OUTFALL DETAIL- LOOKING NW

SCALE: 1"=10' (H) 1'=10' (V)

- EXISTING STONE WALL

EXISTING DITCH MODIFIED

TO ACCEPT OUTFALL

PROPOSED -

RETAINING

AND STORM SEWER LINES IS 10 FEET. • THE MINIMUM SEPARATION BETWEEN WATER SERVICE LINES IS 5 FEET. THE SITE IS LOCATED WITHIN THE TOWN OF CASTLE ROCK PURPLE WATER PRESSURE ZONE. ALL EXISTING UTILITY LOCATIONS SHOWN ARE APPROXIMATE AND MUST BE FIELD VERIFIED BY THE CONTRACTOR.


SDP UTILITY NOTES:

OF CONSTRUCTION PERMITS

 THE FOLLOWING MEASURES SHALL BE IMPLEMENTED, AS RECOMMENDED. AND DESIGNED BY A GEOTECHNICAL ENGINEER: INSTALLATION OF AN IMPERMEABLE LINER AT THE STORM WATER DETENTION POND, AND INCLUSION OF UNDERDRAIN SYSTEMS ON ALL RETAINING WALLS ALONG THE PERIMETER OF THE SITE. UNDERDRAIN SYSTEMS SHALL OUTFALL

ALL PROPOSED EASEMENTS MUST BE RECORDED PRIOR TO ISSUANCE

THE MINIMUM SEPARATION BETWEEN WATERLINES, SANITARY SEWER

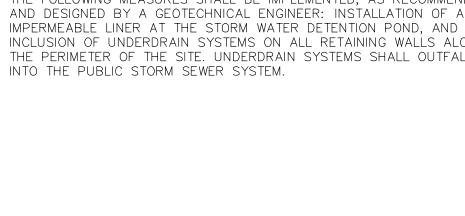

ORIGINAL SCALE: 1" = 50'

BASIS OF BEARING:

AT THE SOUTH, BEING ASSUMED TO BEAR N02d18'30"E

BENCHMARK

#5 REBAR W/O CAP @ SE CORNER OF LOT 1, BLOCK 3, WOODLANDS FILING NO. 8.

LEGEND


----- X ------ PROPOSED FENCE PROPOSED PROPERTY LINE \equiv \equiv \equiv \equiv \equiv \equiv \equiv \equiv Existing curb & Gutter ----- W ---- W -- Existing waterline $----\times$ ---- / --- / - EXISTING TELEPHONE ---- E ---- E = EXISTING ELECTRIC LINE EXISTING STORM SEWER W/MANHOLE ---- Existing edge of asphalt ----- EXISTING EDGE OF CONCRETE

EXISTING DRAINAGE SWALE

(W) EXISTING WATER MANHOLE I EXISTING TELEPHONE PEDESTAL T EXISTING TELEPHONE MANHOLE

E EXISTING ELECTRIC PEDESTAL

M EXISTING WATER VALVE A EXISTING FIRE HYDRANT EXISTING TREES

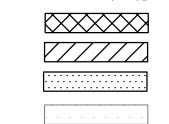

INCLUDED IN DP
(NOT INCLUDED IN WAIVER OF REPLAT) PROPOSED GRAVEL PROPOSED ASPHALT EXISTING ASPHALT

PROPOSED CONCRETE




CALVARY CHAPEL SITE DEVELOPMENT PLAN PROJECT NO: SDP16-0031


DE \overline{S}


SHEET 5 OF 14 JOB NO. **25113.00**

X:\2510000.all\2511300\Drawings\Sheet Dwgs\Development Plan\2018-02-27_Wall Profiles + Cross Sections(1).dwg, North Wall, 5/31/2018 8:02:44 A

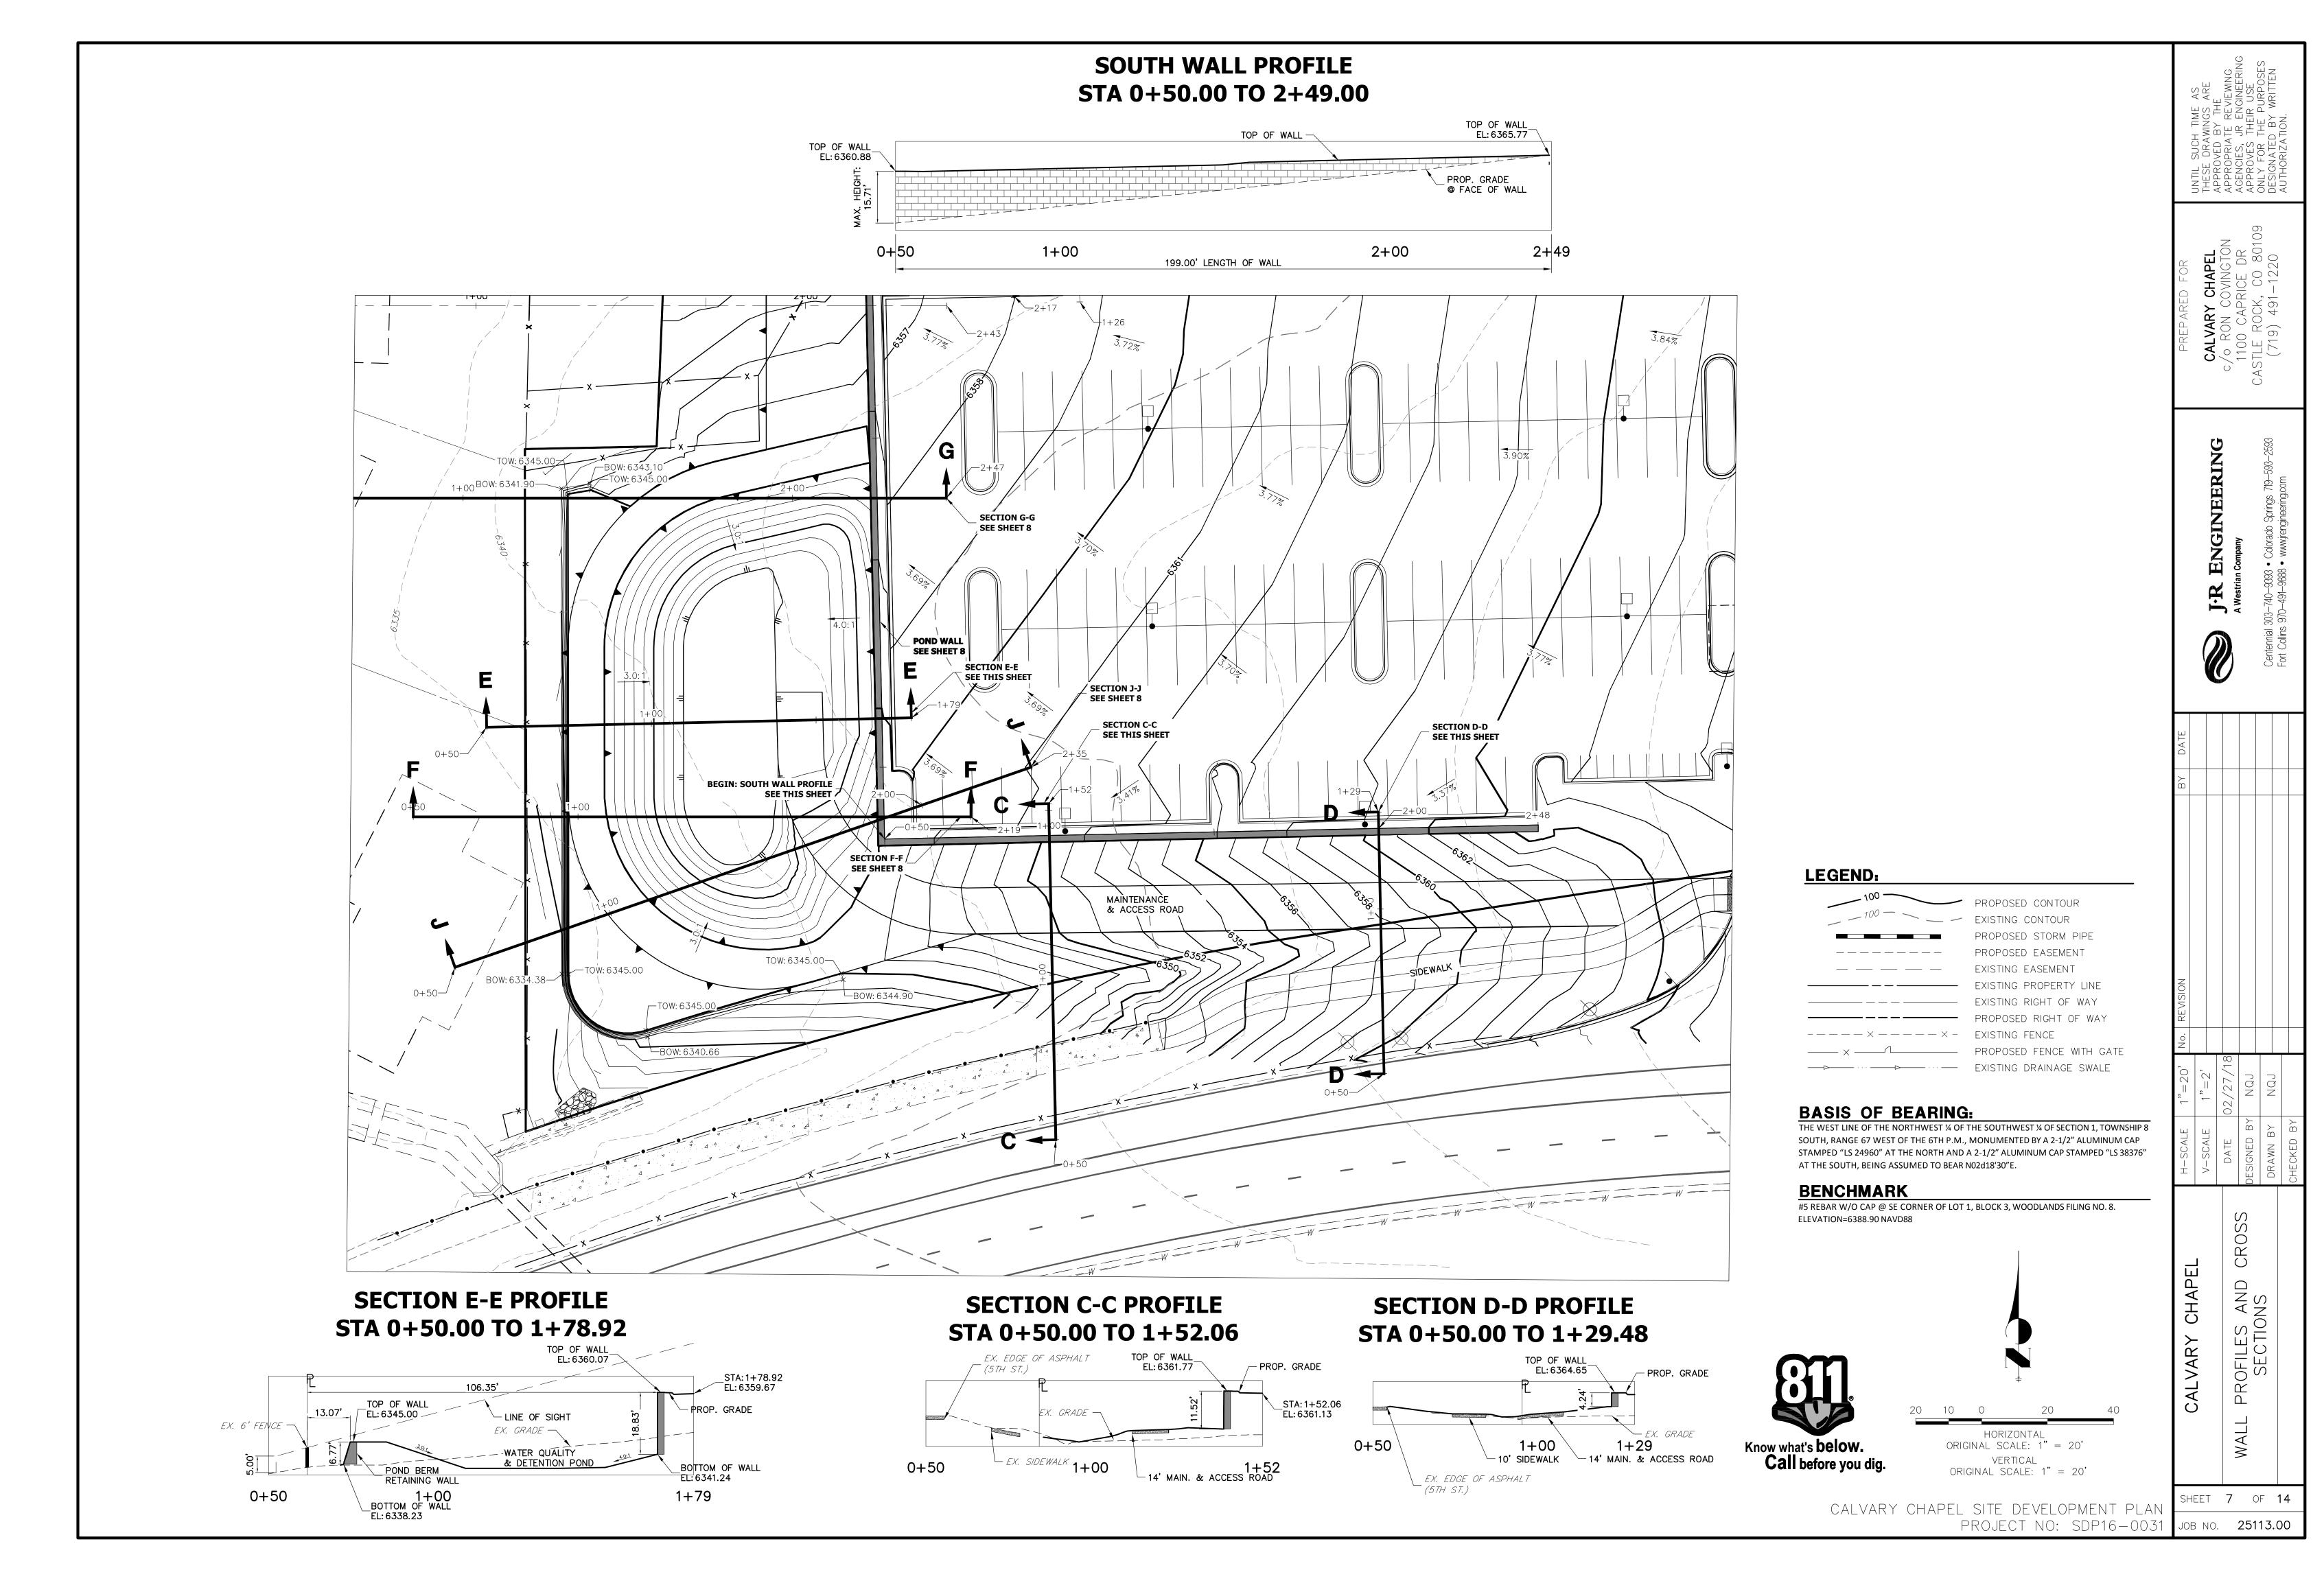

X:\2510000.all\2511300\Drawings\Sheet Dwgs\Development Plan\2018-02-27_Wall Profiles + Cross Secti

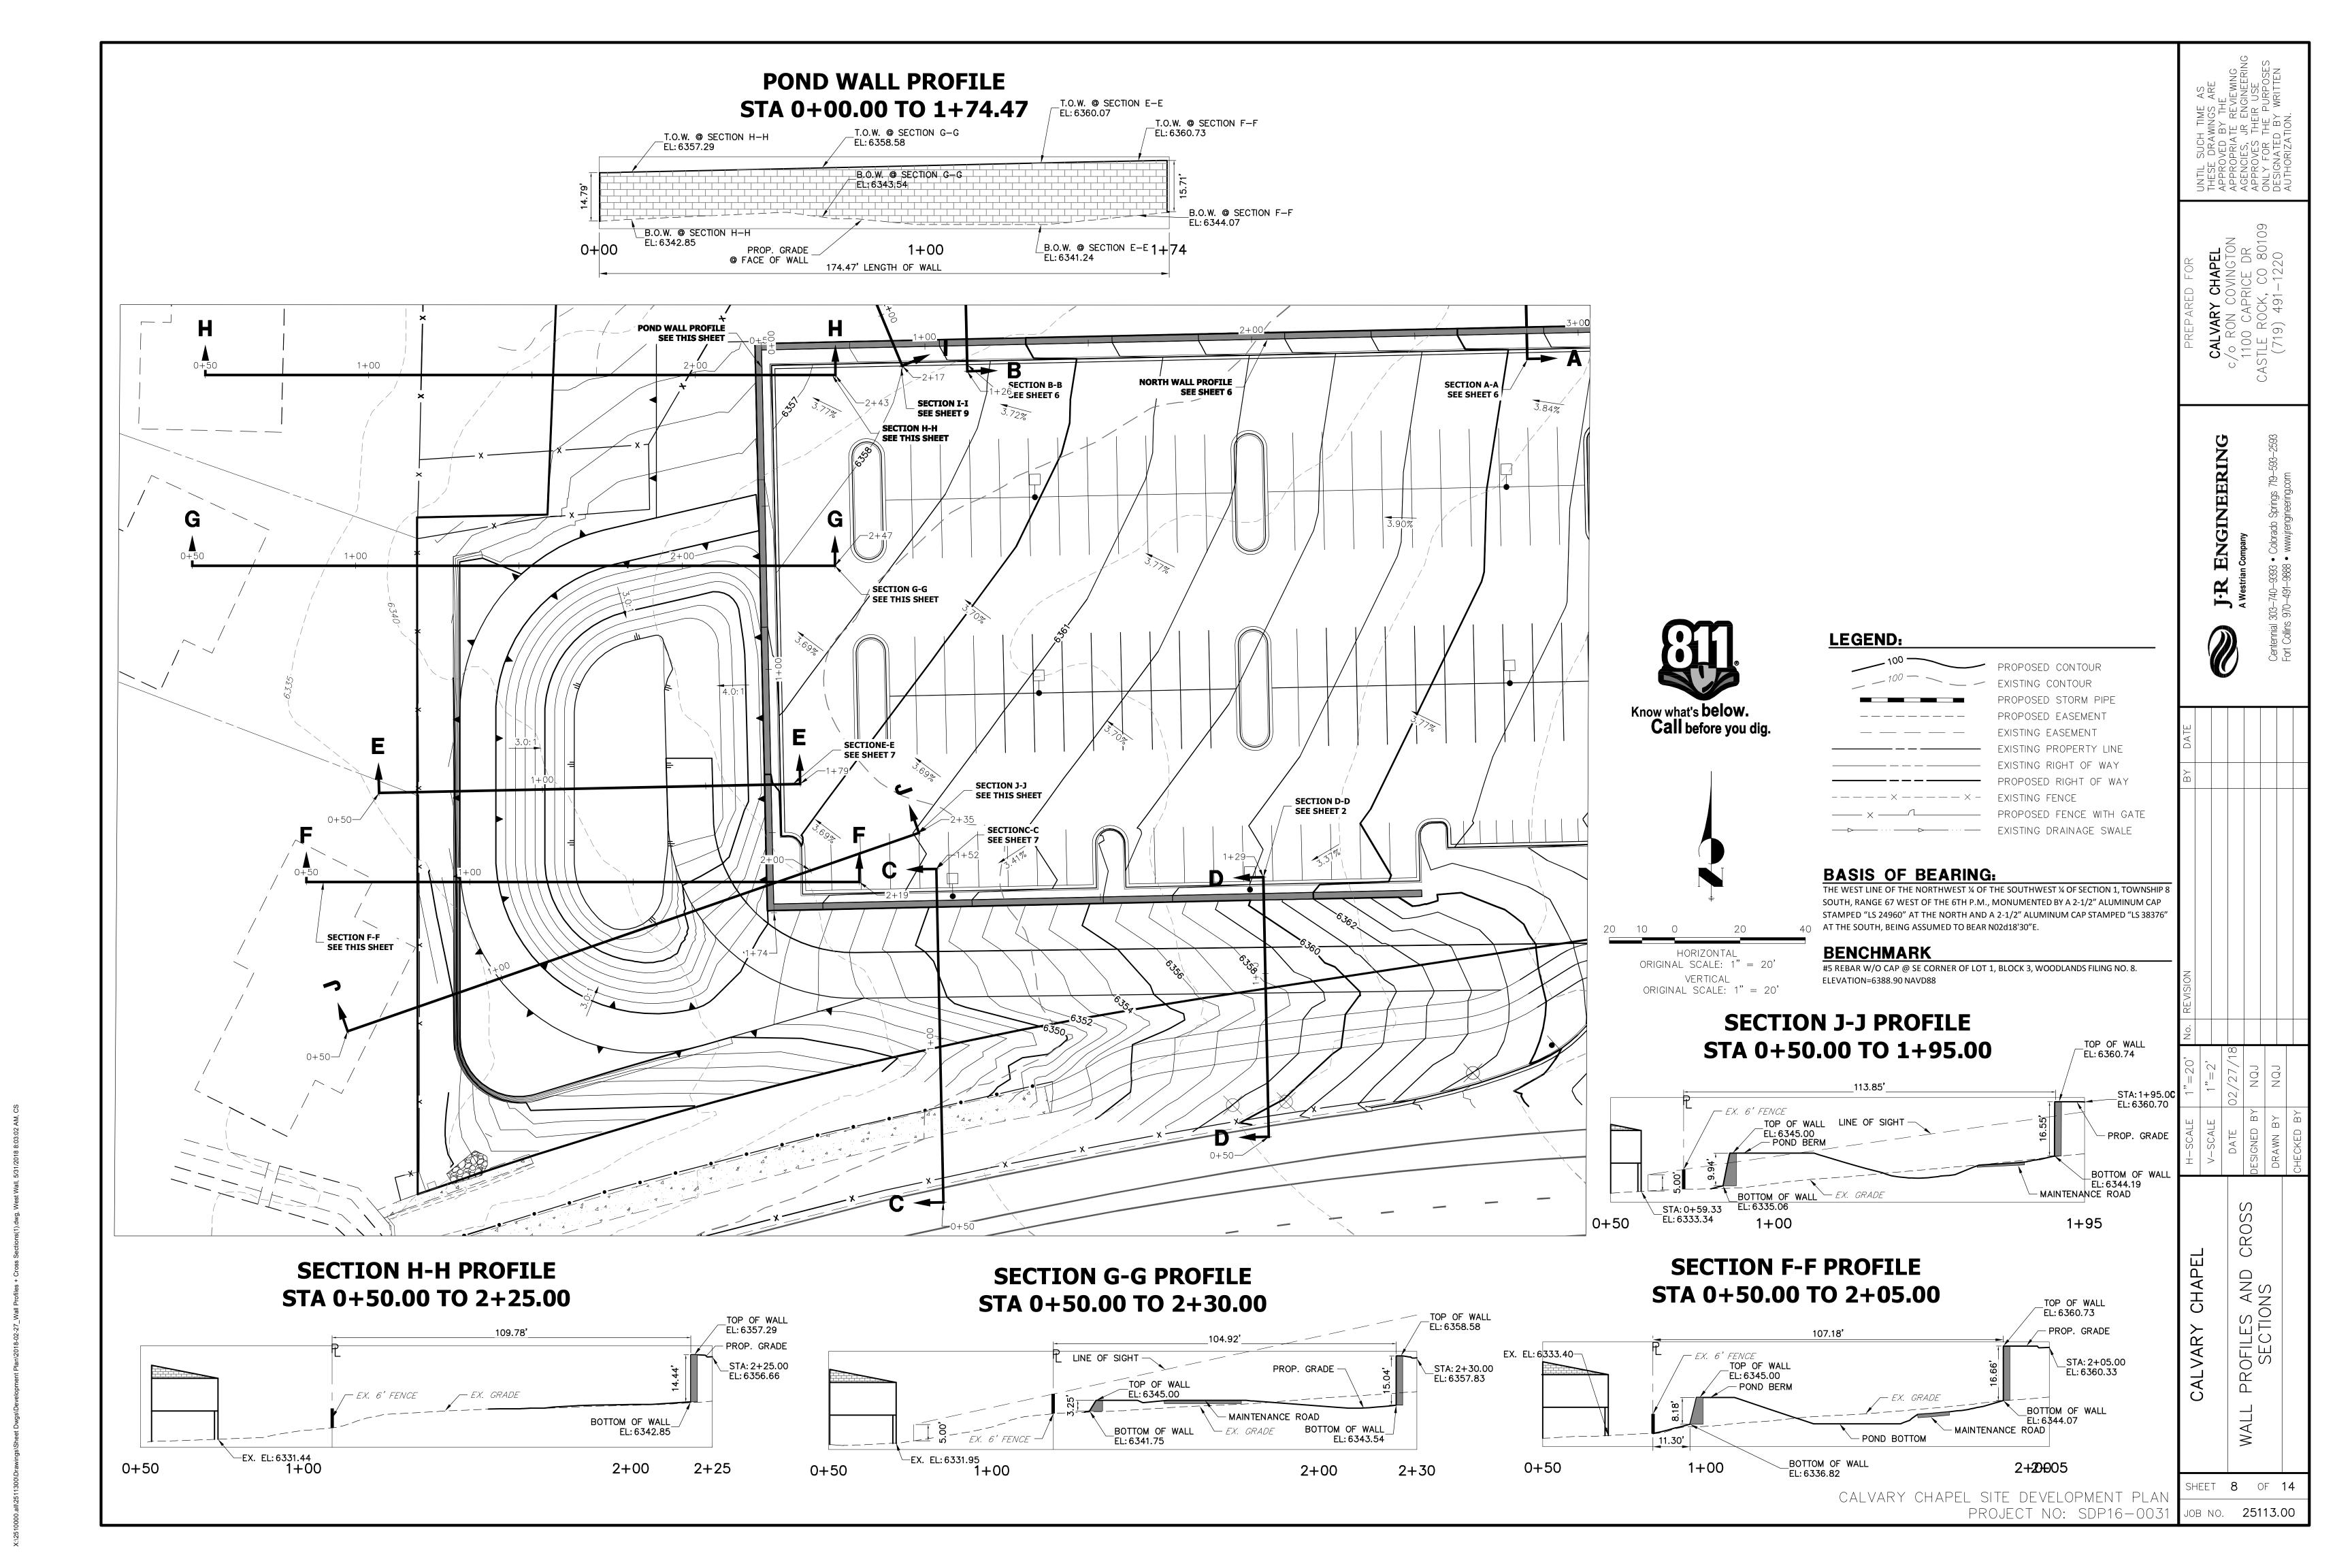

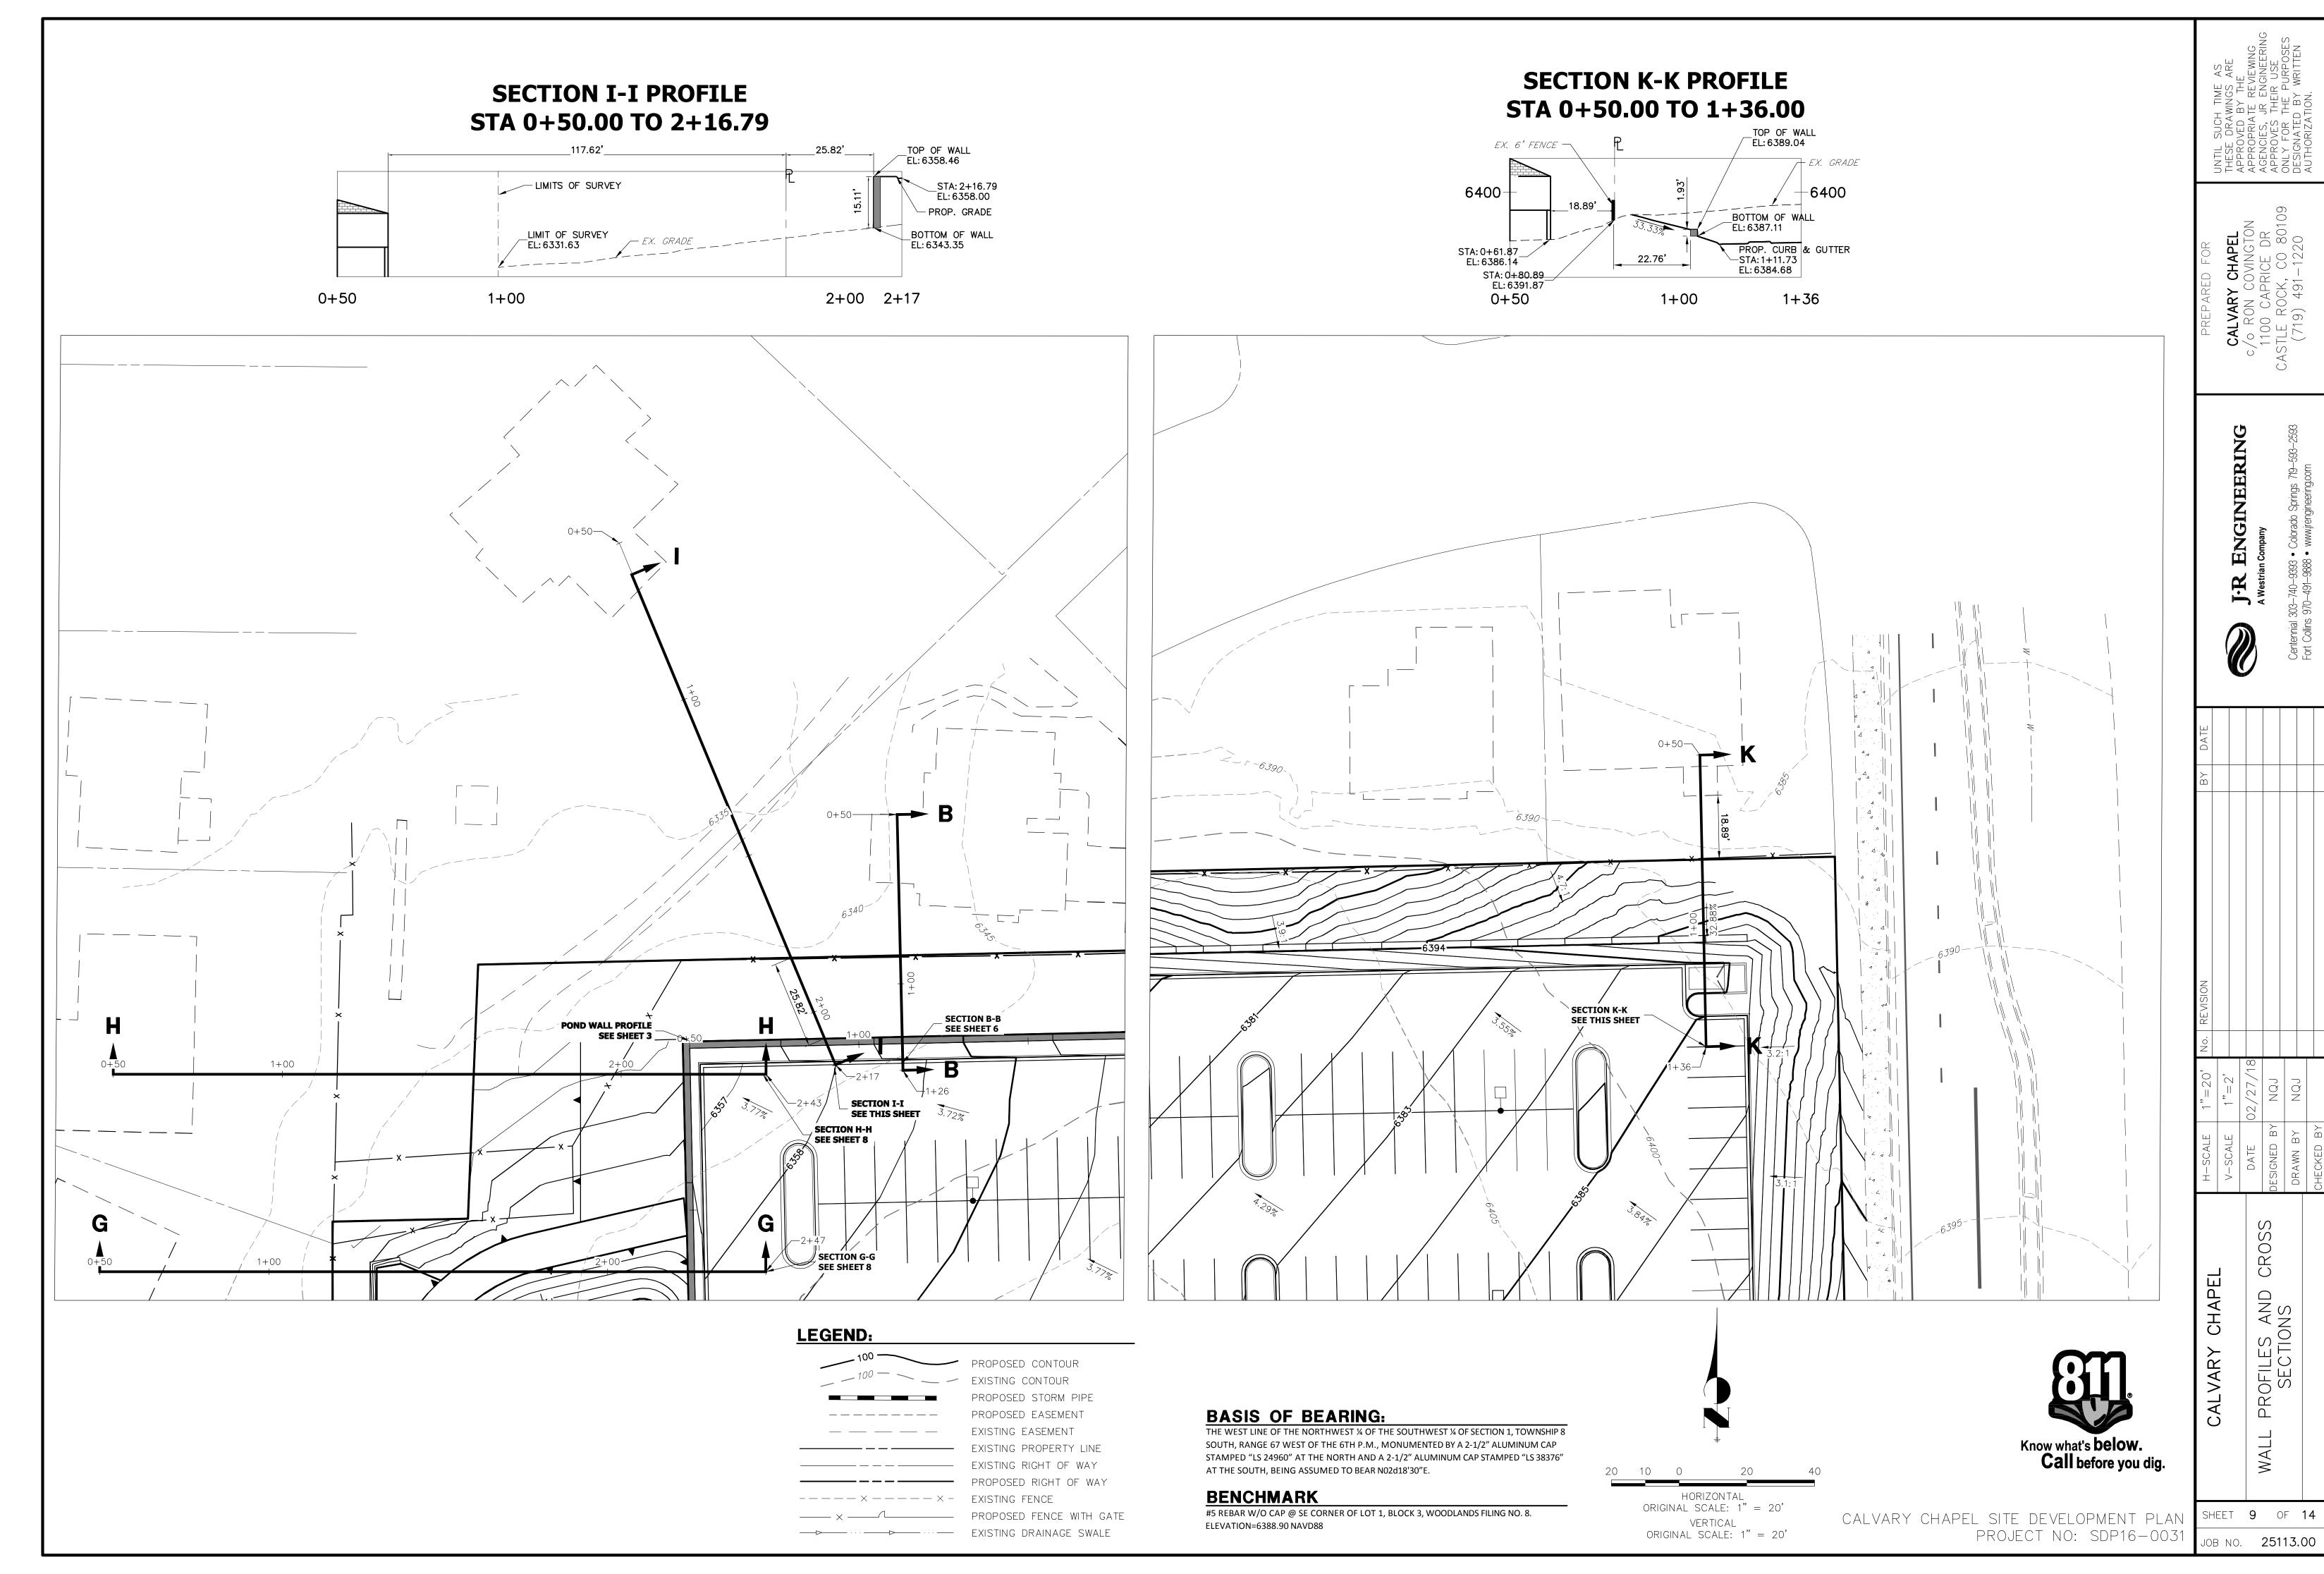

JOB NO. **25113.00**

LOCATED IN THE SOUTHWEST 1/4 OF SECTION 1, TOWNSHIP 8 SOUTH, RANGE 67 WEST OF THE 6TH P.M. COUNTY OF DOUGLAS, STATE OF COLORADO

CONCEPTUAL LANDSCAPE PLAN STANDARD NOTES

- SQUARE FOOTAGES ARE ESTIMATED. FINAL LANDSCAPE AREA COVERAGE SHALL MEET OR EXCEED COVERAGE REPRESENTED IN THIS DRAWING AND SHALL CONFORM TO SUBSEQUENT SUBMITTAL REQUIREMENTS.
- 2. QUANTITIES AND LOCATIONS OF PLANT MATERIALS ARE APPROXIMATED. FINAL QUANTITIES AND LOCATIONS WILL BE REFLECTED ON CONSTRUCTION DOCUMENTS.
- 3. ALL PLANTS ARE TO BE PROPERLY HYDROZONED PER TOWN OF CASTLE ROCK PLANT LIST.
- 4. DISTANCE OF TREES TO UTILITY LINES SHOULD BE A MINIMUM OF 10 FEET.
- 5. PERMANENT IRRIGATION IS REQUIRED FOR ALL LANDSCAPED AREAS GREATER THAN 500 SQUARE FEET, PER SECTION 4.2.3 OF THE LANDSCAPE AND IRRIGATION MANUAL.
- 6. DESIGN MUST ACCOMMODATE THE WATERING RESTRICTIONS AS OUTLINED IN THE TOWN OF CASTLE ROCK WATER USE MANAGEMENT PLAN (WUMP).
- 7. IRRIGATION SYSTEMS ARE TO BE DESIGNED TO OPERATE WITHIN THE TOWN OF CASTLE ROCK WATER USE MANAGEMENT
- 8. IRRIGATION SYSTEMS ARE TO BE DESIGNED PER THE TOWN OF CASTLE ROCK LANDSCAPE AND IRRIGATION REGULATIONS SECTION 4.2.3 AND TO CORRELATE WITH THE USE TYPE ON THE PROPERTY.
- 9. ALL SEED TO BE IRRIGATED WITH POP-SPRAYS OR GEAR DRIVEN ROTORS. TREES, SHRUBS, ORNAMENTAL GRASSES AND PERENNIALS TO BE IRRIGATED WITH SUBSURFACE DRIP IRRIGATION.
- 10. ALL EXISTING SCRUB OAK SHOWN TO REMAIN ON THE DRAWINGS SHALL BE PROTECTED DURING CONSTRUCTION.
- 11. PLACEMENT OF EVERGREEN TREES IN FRONT OF THE WALL ALONG THE NORTHWEST CORNER OF THE SITE TO BE FIELD VERIFIED PRIOR TO INSTALLATION TO ENSURE OPTIMAL LOCATION.

LICENSED LANDSCAPE ARCHITECT SIGNATURE BLOCK

Town of Castle Rock Registered Professional: Jason Alwine

Town of Castle Rock Registration #: _____ State of Colorado Licensed Landscape Architect #: __248

Company Name: ____Thomas & Thomas ___ Address: ___702 N Tejon St., Colorado Springs, CO 80903

Project Name: Calvary Chapel Castle Rock

COMMERCIAL LANDSCAPE SITE INVENTORY FORM:

GROSS SITE AREA	LANDSCAPE AREA IN SQ.FT.	TURFGRASS LIST SPECIES (AREA IN SQ.FT.)	NONLIVING ORNAMENTAL (AREA IN SQ.FT.)	NO. OF TREES REQUIRED	NO. OF TREES PROVIDED	NO. OF SHRUBS REQUIRED	NO. OF SHRUBS PROVIDED	SOIL PREP AMOUNTS (IN CU.YDS. PER 1000 SQ.FT.)	SEPARATE IRRIGATION SERVICE CONNECTIONS
236,722 SF	103,890 SF	LOW GROW MIX NATIVE SEED GRASS PER THE MATERIALS SCHEDULE 74,863 SF	WOOD MULCH 13,828 SF	47	43+ (4) EXISTING SCRUB OAKS	95	534	ESTIMATED 4 CY PER 1000 SQ.FT. PENDING SOIL ANALYSIS WITH CD'S	_X_YES NO
PARKING LOT (AREA IN SQ.FT.)	PARKING LOT LANDSCAPE AREA (SQ.FT.)	NO. OF PARKING SPACES	NONLIVING ORNAMENTAL (AREA IN SQ.FT.)	NO. OF INTERIOR LANDSCAPE ISLANDS	MINIMUM WIDTH OF INTERIOR LANDSCAPE ISLANDS	NO. OF TREES REQUIRED	NO. OF TREES PROVIDED	NO. OF SHRUBS REQUIRED	NO. OF SHRUBS PROVIDED
99,189 SF	10,272 SF	253	ROCK MULCH 12,059 SF	14	8'	20	20	40	40

LANDSCAPE M	ATERIAL SCHEDULE
SYMBOL/ CALLOUT	NOTES:
SEED	IRRIGATED NATIVE SEED: To be a pre-blended mix known as "Low Grow Mix" containing 30% Ephraim Crested Wheatgrass, 25% Dwarf Perennial Ryegrass, 20% SR3200 Blue Fescue, 15% Reubens Canada Bluegrass, 10% Chewings Fescue. Install per supplier's specifications for new seeding. Submit cut-sheet for approval prior to installation. Contact Sharp Brothers Seed Co. (1-800-462-8483)
W.M.	SHREDDED WOOD MULCH: To be organic shredded cedar wood mulch installed to a depth of 4". NO weed barrier fabric. Install per plan locations. Submit cut-sheet & sample for approval prior to installation.
S.E.	STEEL EDGE: Steel edge to be DURAEDGE 3/16" Thick x 5" Wide Rolled Top Steel Edge. Color to be 'Green'. Install per manufacturer's specifications. Submit cut-sheet & sample for approval prior to installation.
Rock	ROCK MULCH: 1.5" NATURAL COLOR gravel, TAN color installed to a depth of 4" on weed barrier fabric. Install per plan locations. Submit cut-sheet & sample for approval prior to installation.
	BOULDER: Boulders to be COTTONWOOD. Size to vary, minimum size 18" x 18" x 18"

STREET TREE AND SHRUB REQUIREMENT

STREET	FRONTAGE LINEAR FEET	NO. OF TREES REQUIRED (1 TREE/ 40' LINEAR FEET)	NO. OF TREES PROVIDED	NO. OF SHRUBS REQUIRED (4 SHRUBS/ 40 LINEAR FEET)	NO. OF SHRUBS PROVIDED
FIFTH STREET	979'	24	24	98	98
WOODLANDS BLVD.	274'	7	7	27	27
TOTAL	1253'	31	31	125	125

SOIL AMENDMENTS:

FOR THIS SITE THE FOLLOWING AMENDMENTS ARE TO BE INCORPORATED:

- 1. APPLY 4 CY/ 1,000 SQ. FT. ORGANIC MATTER SOIL AMENDMENT. TILL INTO TOP 6" OF SOIL.
- 2. SOIL AMENDMENT ORGANIC MATTER SHALL CONSIST OF EITHER CLASS 1 OR CLASS II COMPOST. 3. SUBMIT CUT-SHEET FOR REVIEW AND APPROVAL PRIOR TO INSTALLATION. 4. FERTILIZER TO BE PER THE SOILS ANALYSIS REPORT COMPLETED WITH THE CONSTRUCTION DOCUMENTS.

PLANT SCHEDULE

SHRUBS CODE QTY BOTANICAL NAME

TREES	CODE	QTY	BOTANICAL NAME	COMMON NAME	H2O USE	HEIGHT	WIDTH	SIZE	NOTES	IRRIGATION	WATER REQUIREMENTS (IN/MO)
+	СО	5	CELTIS OCCIDENTALIS	WESTERN HACKBERRY	LOW	55'	45'	2.0" Caliper	B&B	DRIP	
4 4 4 4 4 4 4 4 4 4 4 4 4 4 4 4 4 4 4	GS	14	GLEDITSIA TRIACANTHOS INERMIS 'SKYLINE'	SKYLINE HONEYLOCUST	LOW	45'	40'	2.0" Caliper	B&B	DRIP	
	GD	18	GYMNOCLADUS DIOICA	KENTUCKY COFFEETREE	LOW	50'	45'	2.0" Caliper	B&B	DRIP	
·	MR	8	MALUS SP. 'RADIANT'	RADIANT CRABAPPLE	LOW	25'	20'	1.5" Caliper	B&B	DRIP	
	PN	11	PINUS NIGRA	AUSTRIAN PINE	LOW	50'	35'	6' HT	B&B	DRIP	
	PP	4	PINUS PONDEROSA	PONDEROSA PINE	LOW	60'	35'	6' HT	B&B	DRIP	
	PF	9	PINUS FLEXILIS	LIMBER PINE	LOW	35'	15'	6' HT	B&B	DRIP	
*	PPC	7	PICEA PUNGENS	COLORADO BLUE SPRUCE	LOW	40'	20'	6' HT	B&B	DRIP	
·	PV	3	PRUNUS VIRGINIANA 'SHUBERT'	CANADA RED CHOKECHERRY	LOW	25'	20'	1.5" Caliper	B&B	DRIP	
	QR	15	QUERCUS RUBRA	NORTHERN RED OAK	LOW	75'	45'	2.0" Caliper	B&B	DRIP	

H2O USE | HEIGHT | WIDTH | SIZE | NOTES | IRRIGATION | WATER REQUIREMENTS (IN/MO)


COMMON NAME


+	втс	116	BERBERIS THUNBERGII 'CRIMSON PYGMY'	CRIMSON PYGMY BARBERRY	LOW	2'	3'	5 GAL	CONTAINER	DRIP	
\odot	AA	3	AMELANCHIER ALNIFOLIA	SASKATOON SERVICEBERRY	LOW	15'	15'	1.5" Caliper	B&B	DRIP	
	BTR	3	BERBERIS THUNBERGII 'ATROPURPUREA'	REDLEAF BARBERRY	LOW	6'	6'	5 GAL	CONTAINER	DRIP	
	CSI	39	RHUS AROMATICA 'GROW-LOW'	GRO-LOW SUMAC	LOW	3'	6'	5 GAL	CONTAINER	DRIP	
	DB	28	DAPHNE X BURKWOODI ' CAROL MACKIE'	CAROL MACKIE DAPHNE	MEDIUM	3'	4'	5 GAL	CONTAINER	DRIP	
	JS	6	JUNIPERUS SCOPULORUM	ROCKY MOUNTAIN JUNIPER	LOW	25'	15'	6' HT	B&B	DRIP	
Sandy Mary Mary	JHB	77	JUNIPERUS HORIZONTALUS 'BLUE CHIP'	BLUE CHIP JUNIPER	LOW	1'	8'	5 GAL	CONTAINER	DRIP	
*	JSS	6	JUNIPERUS SCOPULORUM 'SKYROCKET'	SKYROCKET JUNIPER	LOW	15'	4'	5 GAL	CONTAINER	DRIP	
	POD	11	PHYSOCARPUS OPULIFOLIUS 'DIABLO'	DIABLO NINEBARK	LOW	8'	8'	5 GAL	CONTAINER	DRIP	
ZW Z	PMS	43	PINUS MUGO 'SLOWMOUND'	SLOWMOUND MUGO PINE	LOW	4'	6'	5 GAL	CONTAINER	DRIP	
Selle de la constant	PMM	23	PINUS MUGO 'MOPS'	MOPS MINIATURE MUGO PINE	LOW	3'	3'	5 GAL	CONTAINER	DRIP	
\bigcirc	PFG	47	POTENTILLA FRUITICOSA 'GOLDFINGER'	GOLDFINGER POTENTILLA	LOW	3'	4'	5 GAL	CONTAINER	DRIP	
	RMW	110	ROSA X MEIDILAND WHITE	MEIDILAND WHITE ROSE	LOW	2'	5'	5 GAL	CONTAINER	DRIP	
\odot	SJG	50	SPIREA JAPONICA 'GOLDFLAME'	GOLDFLAME SPIREA	LOW	3'	3'	5 GAL	CONTAINER	DRIP	
*	JP	137	JUNIPERUS × PFITZERIANA 'SEA GREEN'	SEAGREEN JUNIPER	LOW	3'	3'	5 GAL	CONTAINER	DRIP	

		_									
PERENNIALS & GRASSES	CODE	QTY	BOTANICAL NAME	COMMON NAME	H2O USE	HEIGHT	WIDTH	SIZE	NOTES	IRRIGATION	WATER REQUIREMENTS (IN/MO)
©	CG	92	COREOPSIS GRANDIFLORA 'EARLY SUNRISE'	EARLY SUNRISE TICKSEED	LOW	12"	12"	1 GAL	CONTAINER	DRIP	
	EH	21	ECHINACEA HYBRIDA 'CHEYENNE SPIRIT'	CHEYENNE SPIRIT CONEFLOWER	LOW	24"	12"	1 GAL	CONTAINER	DRIP	
	GSB	14	GERANIUM SANGUINEUM	BLOODY PINK CRANESBILL	MEDIUM	12"	18"	1 GAL	CONTAINER	DRIP	
	РВ	47	PENSTEMON BARBATUS 'RIDING HOOD RED'	RIDING HOOD BEARDTONGE	LOW	12"	12"	1 GAL	CONTAINER	DRIP	
(23)	LS	11	LEUCANTHEMUM X SUPERBUM 'ALASKA'	ALASKA SHASTA DAISEY	MEDIUM	24"	18"	1 GAL	CONTAINER	DRIP	
	SN	30	SALVIA NEMOROSA 'MAY NIGHT'	MAY NIGHT MEADOW SAGE	LOW	18"	18"	1 GAL	CONTAINER	DRIP	
**	CA	9	CALAMAGROSTIS ACUTIFLORA ' AVALANCHE'	VARIGATED FEATHER REED GRASS	LOW	3'	24"	1 GAL	CONTAINER	DRIP	
(8)	SS	7	SCHIZACHYRIUM SCORPIUM 'BLAZE'	LITTLE BLUE STEM	LOW	3"	24"	1 GAL	CONTAINER	DRIP	
	CAF	89	CALAMAGROSTIS ACUTIFLORA 'KARL FOERSTER'	KARL FOERSTER FEATHER REED GRASS	LOW	4'	2'	5 GAL	CONTAINER	DRIP	
*	FG	99	FESTUCA GLAUCA 'BOULDER BLUE'	BOULDER BLUE FESCUE	LOW	8"	8"	1 GAL	CONTAINER	DRIP	
0	MS	4	MISCANTHUS SINENSIS	MAIDEN GRASS	LOW	10'	4'	1 GAL	CONTAINER	DRIP	
	PA	36	PEROVSKIA ATRIPLICIFOLIA	RUSSIAN SAGE	LOW	4'	4'	5 GAL	CONTAINER	DRIP	
L					1		1				


THOM, S


F	<u> </u>				<u>°</u> °	
VED						
APPRO						
DRAWN CHECKED APPROVED						
DRAWN						
DATE	07/19/17	9/28/17	11/2/17	2/2/18	3/30/18	4/18/18

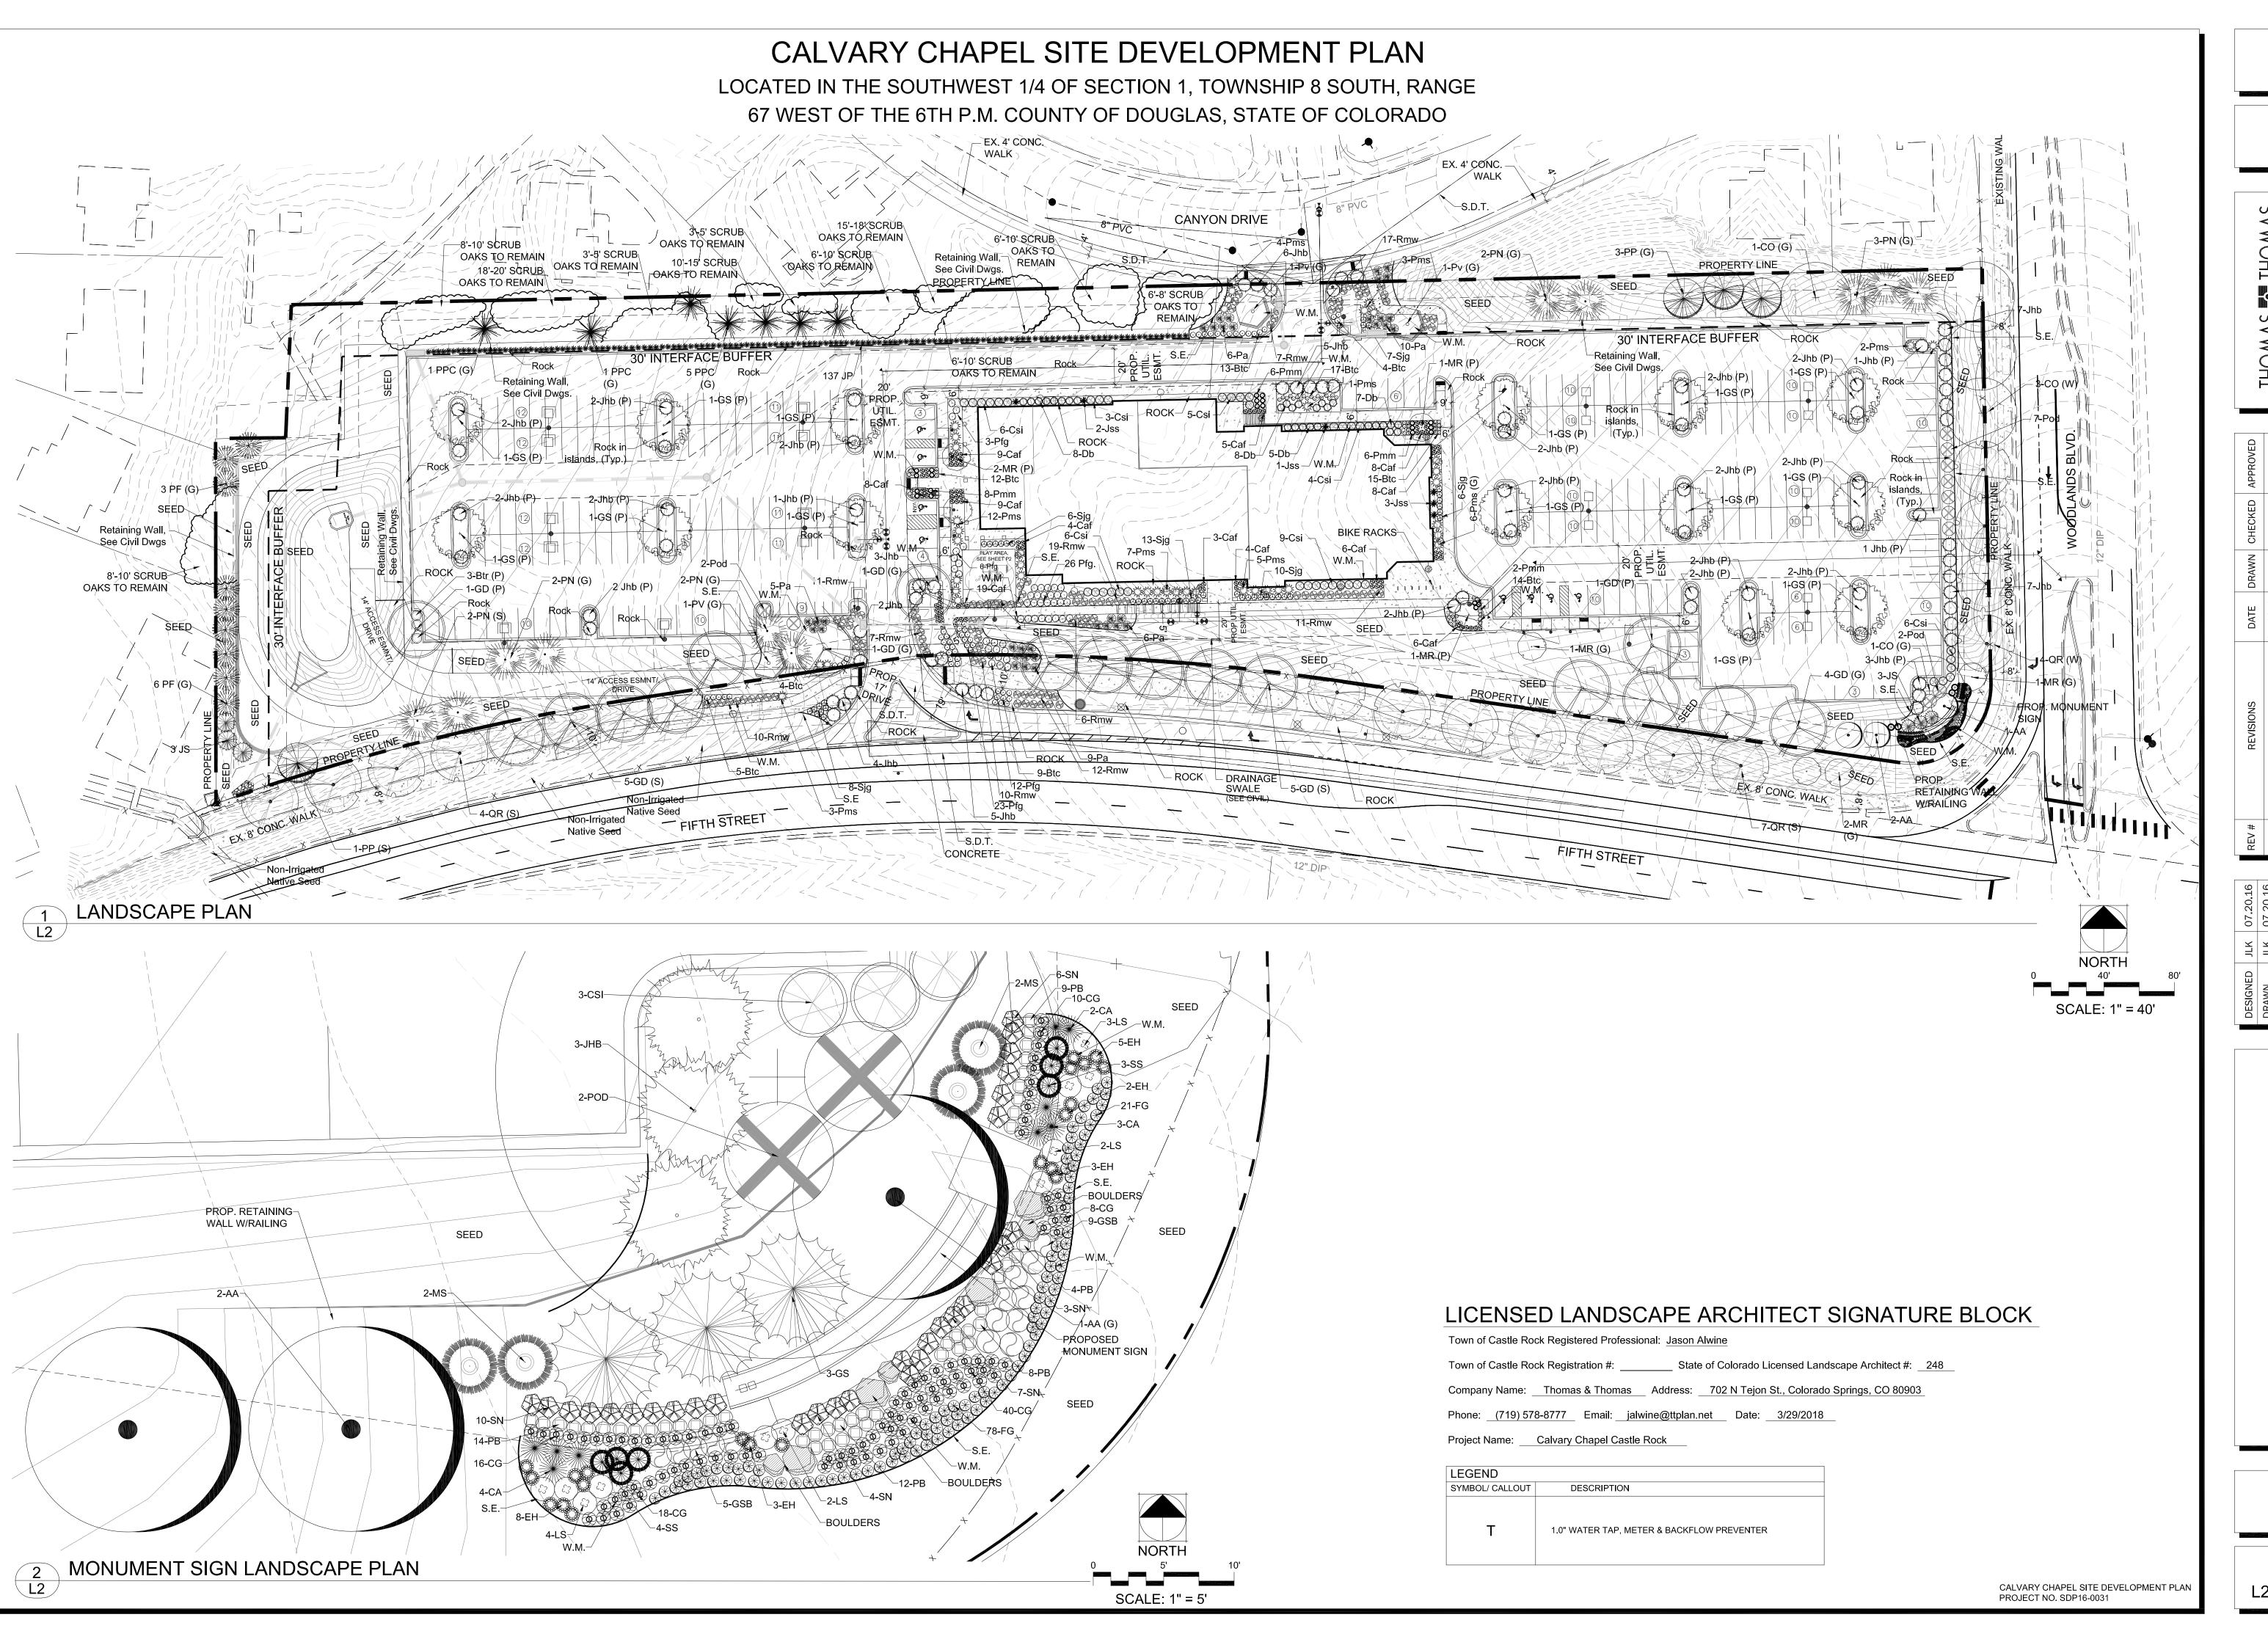

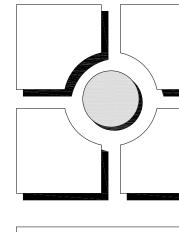

#	REVISIONS	DATE	DRAWN	DRAWN CHECKED	APPROVED
	TOWN REVISIONS REV 2	07/19/17			
	TOWN REVISIONS REV. 3	9/28/17			
	TOWN REVISIONS REV. 4	11/2/17			
	TOWN REVISIONS REV. 5	2/2/18			
	TOWN REVISIONS REV. 6/7	3/30/18			
	TOWN REVISIONS REV. 8	4/18/18			

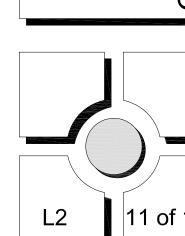

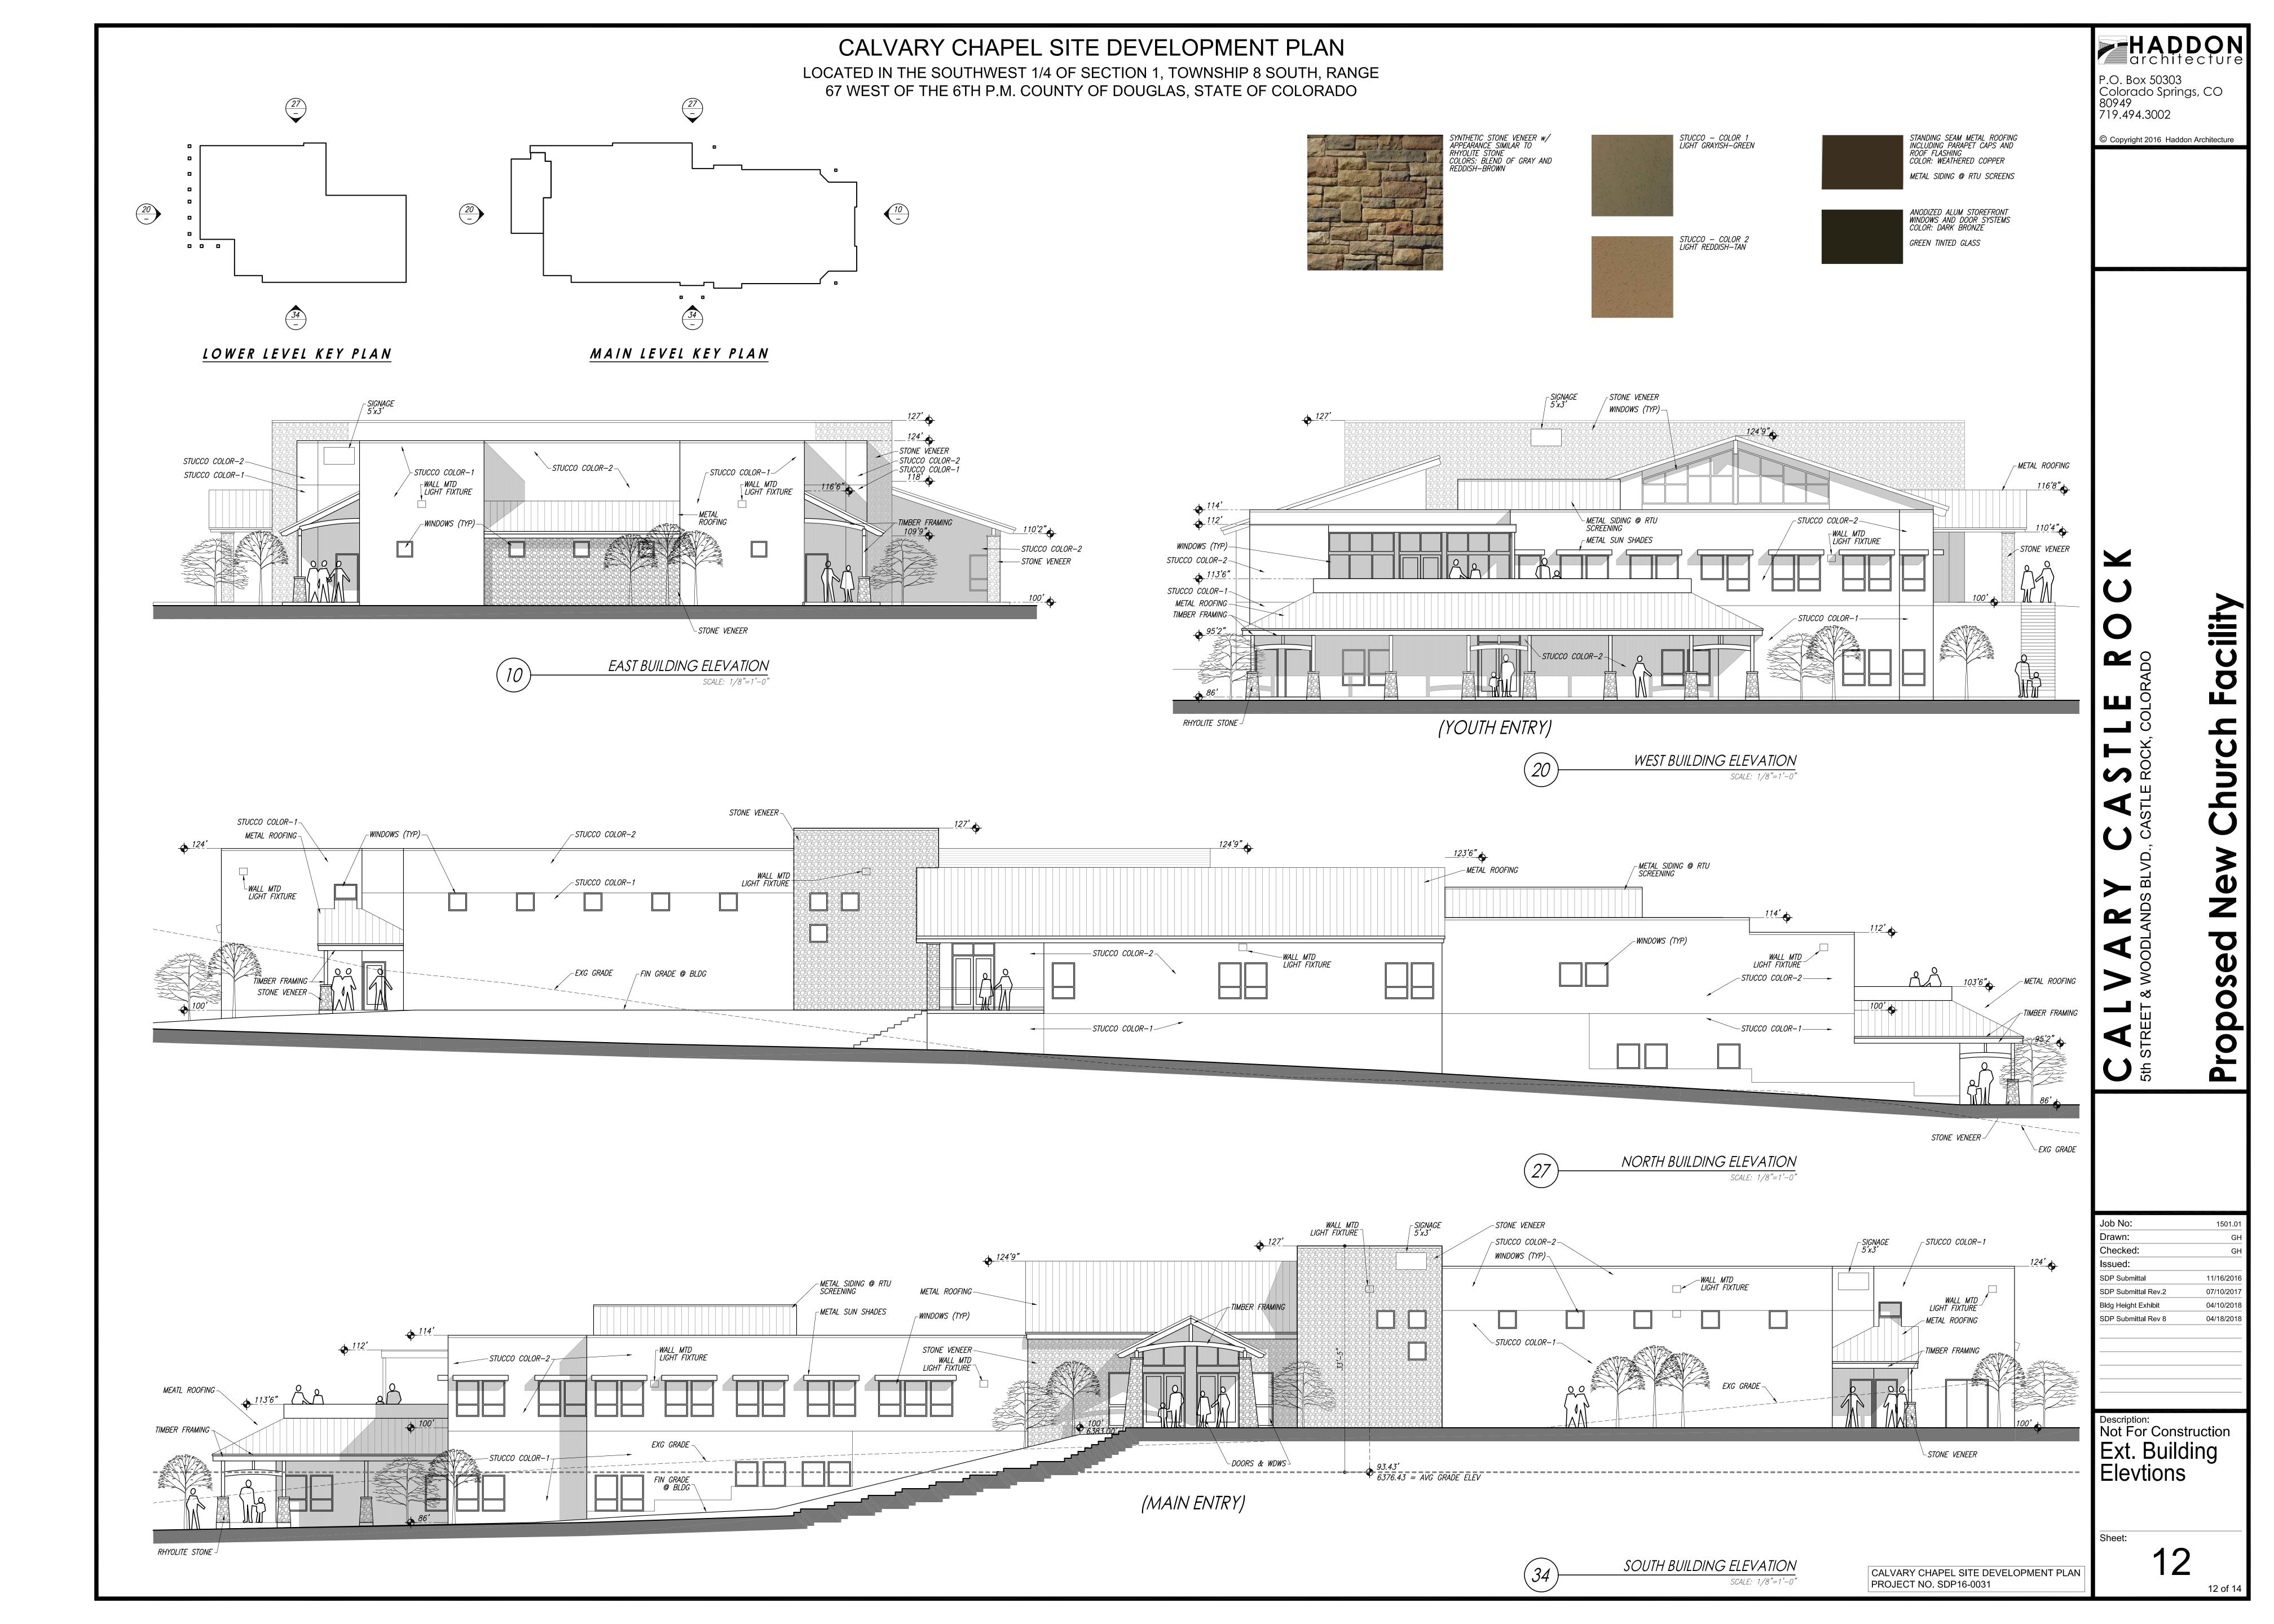

LOCATED IN THE SOUTHWEST 1/4 OF SECTION 1, TOWNSHIP 8 SOUTH, RANGE 67 WEST OF THE 6TH P.M. COUNTY OF DOUGLAS, STATE OF COLORADO

REMARKS

ARCHITECTURAL AREA LIGHT, SINGLE HEAD, TYPE 5SQ DISTRIBUTION, MIN 70 CRI,

5-YEAR LIMITED WARRANTY, MIN 0.9 PF, <20% THD, WITH INTEGRAL SURGE

PROTECTOR, DARK SKY COMPLIANT, FULL CUT OFF. SEE NOTES 1, 2, & 5.

ARCHITECTURAL AREA LIGHT, SINGLE HEAD, TYPE 2 DISTRIBUTION, MIN 70 CRI,

5-YEAR LIMITED WARRANTY, MIN 0.9 PF, <20% THD, WITH INTEGRAL SURGE

5-YEAR LIMITED WARRANTY, MIN 0.9 PF, <20% THD, WITH INTEGRAL SURGE

5-YEAR LIMITED WARRANTY, MIN 0.9 PF, <20% THD, WITH INTEGRAL SURGE

PROTECTOR, DARK SKY COMPLIANT, FULL CUT OFF. SEE NOTES 1, 2, & 5.

ARCHITECTURAL LED WALL PACK, DARK SKY COMPLIANT, FULL CUT OFF,

ARCHITECTURAL LED WALL PACK, DARK SKY COMPLIANT, FULL CUT OFF,

ARCHITECTURAL LED WALL PACK, DARK SKY COMPLIANT, FULL CUT OFF,

ARCHITECTURAL LED WALL PACK, DARK SKY COMPLIANT, FULL CUT OFF,

ARCHITECTURAL LED WALL PACK, DARK SKY COMPLIANT, FULL CUT OFF,

WET LOCATION LISTED, 0-10V DIMMING, 5 YEAR WARRANTY.

SEE NOTES 3 AND 4.

SEE NOTES 3 AND 4.

SEE NOTES 3 AND 4.

SEE NOTE 3.

PROTECTOR, DARK SKY COMPLIANT, FULL CUT OFF. SEE NOTES 1, 2, & 5.

ARCHITECTURAL AREA LIGHT, DOUBLE HEAD, TYPE 3 DISTRIBUTION, MIN 70 CRI,

PROTECTOR, DARK SKY COMPLIANT, FULL CUT OFF. SEE NOTES 1, 2, & 5.

ARCHITECTURAL AREA LIGHT, SINGLE HEAD, TYPE 2 DISTRIBUTION, MIN 70 CRI,


GENERAL NOTES

- A. THIS PLAN IS BASED ON THE INFORMATION AVAILABLE. THE LUMINAIRE LOCATIONS SHOWN MUST BE COORDINATED WITH EXISTING OR FUTURE FIELD CONDITIONS.
- B. ALL LUMINAIRES NOT DESIGNATED AS 'SEC' SHALL BE ON FROM DUSK TO PRESET TIME USING SITE PHOTO CELL AND TIME CLOCK. COORDINATE TIMES FOR EACH DAY WITH THE OWNER.
- C. ALL LIGHTS ON PROPERTY ADJACENT TO RESIDENTIAL ZONED LAND, EXCEPT FOR THOSE USED FOR SECURITY AT ENTRANCES, SHALL BE CIRCUITED SUCH THAT LIGHTING SHALL BE REDUCED BY 50% WITHIN ONE HOUR AFTER THE END OF BUSINESS HOURS AND BE OPERATED IN SUCH 50% REDUCED MODE UNTIL ONE HOUR PRIOR TO THE COMMENCEMENT OF BUSINESS HOURS. LIGHTING CLOSEST TO THE BUILDING OR STRUCTURES SHALL BE CIRCUITED SEPARATELY FROM LIGHTING ON THE PROPERTY PERIMETER TO ALLOW AFTER HOUR (POST-CURFEW) CONTROLS.
- D. LIGHT FIXTURES SHALL BE INSTALLED AND MAINTAINED IN A MANNER CONSISTENT WITH THE LIGHTING PLAN APPROVED BY THE TOWN OF CASTLE ROCK. THE PROPERTY OWNER SHALL BE RESPONSIBLE FOR THE PROPER MAINTENANCE OF LIGHTING FIXTURES ON THEIR PROPERTY
- FIXTURES ON THEIR PROPERTY.

 E. FORWARD THROW (TYPE 4) DISTRIBUTION, POLE MOUNTED LIGHTS AIMED AT THE BUILDING FACADE AND UNSHIELDED
- F. SEE ADDITIONAL GENERAL NOTES ON E101.

WALL PACKS ARE PROHIBITED.

OFF CUEFT FACA FOR LIGHT FIXTURE OUT OUTFITS

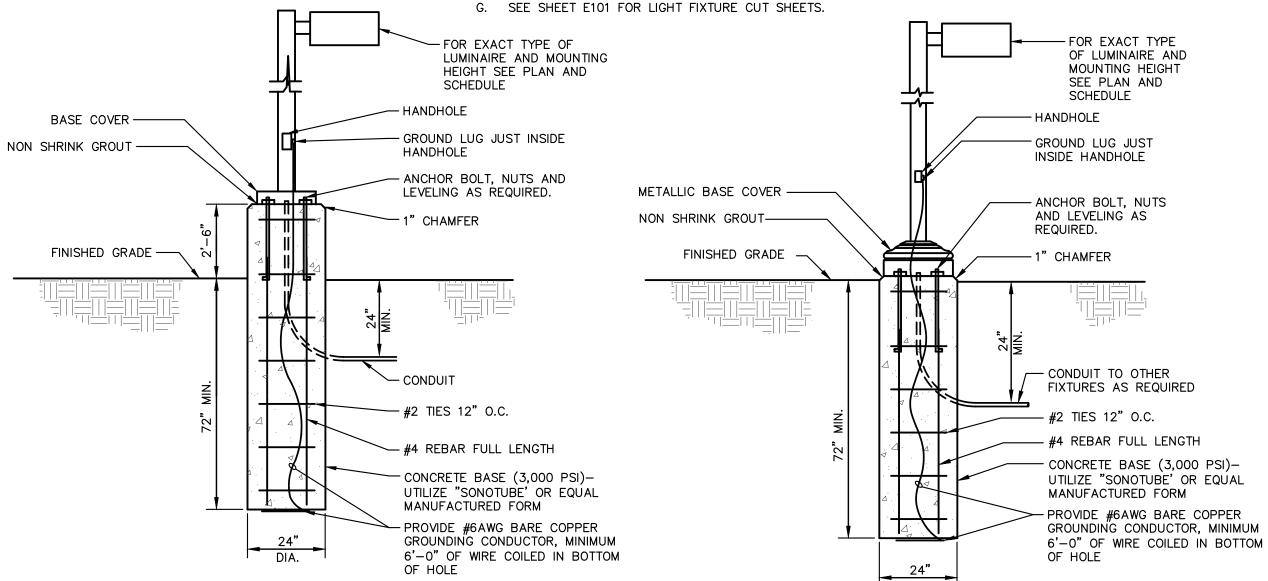

TYPICAL POLE BASE DETAIL

NOT TO SCALE

LUMINAIRE SCHEDULE NOTES:

LUMINAIRE SCHEDULE

P5H

T2H

T2AH

VS-EM

VM-EM

VM1-EM

VM2

MANUFACTURER

BEACON

BEACON

BEACON

BEACON

H. E. WILLIAMS

^L(EX) TELEPHONE PEDESTAL

. ELECTRICAL CONTRACTOR SHALL PROVIDE A COMPLETE FUNCTIONING SYSTEM, INCLUDING ALL PARTS REQUIRED.

19'-4"

- 2. 'SEC' INDICATES THAT THE LUMINAIRE SHALL BE WIRED AS A SECURITY LIGHT (ON FROM DUSK TO DAWN) USING SITE PHOTOCELL. SEE GENERAL NOTES REGARDING POST—CURFEW LIGHT LEVEL REQUIREMENTS.
- 3. HEIGHT ABOVE GRADE IS APPROXIMATE. COORDINATE EXACT MOUNTING HEIGHT WITH ARCHITECTURAL ELEVATIONS.
- 4. FIXTURES DESIGNATED WITH "-EM" INDICATE THAT THE LIGHT IS TO BE CONNECTED TO AN INDOOR INVERTER OR INDOOR BATTERY PACK LISTED FOR UL 924 EMERGENCY EGRESS LIGHTING.

SERIES

VIPER SMALL 36L-65 SERIES

TYPE 5SQ DISTRIBUTION

VIPER SMALL 36L-80 SERIES

TYPE 2 DISTRIBUTION

VIPER SMALL 36L-65 SERIES

TYPE 2 DISTRIBUTION

VIPER SMALL 36L-80 SERIES

TYPE 3 DISTRIBUTION

VOLTAIRE MINI ARCHITECTURAL WALL PACK

LOW LUMEN OUTPUT

VOLTAIRE MINI ARCHITECTURAL WALL PACK

MEDIUM LUMEN OUTPUT

VOLTAIRE MINI ARCHITECTURAL WALL PACK

MEDIUM LUMEN OUTPUT

VOLTAIRE MINI ARCHITECTURAL WALL PACK

MEDIUM LUMEN OUTPUT

VOLTAIRE MINI ARCHITECTURAL WALL PACK

HIGH LUMEN OUTPUT

5. CONTACT FACTORY TO REQUEST WIRING LEADS FOR THE PURPOSE OF EXTERNAL DIMMING CONTROLS.

TOTAL OF EACH | HEIGHT ABOVE

GRADE

25'

25'

LUMINAIRE TYPE

6. FIXURES DESIGNATED WITH "H" INDICATE THAT THE LIGHT HEAD IS TO BE INSTALLED WITH A FACTORY-FURNISHED HOUSE-SIDE-SHIELD. VERIFY EXACT CATALOG NUMBER OF HOUSE-SIDE-SHIELD WITH ORIENTATION SHOWN.

LAMPS

QTY/TYPE

3000K

3000K

LED

3000K

3000K

LED

3000K

1000 LM

LED

3000K

1700 LM

LED

3000K

1700 LM

LED

3000K

1700 LM

LED

300K

2000 LM

FINISH

DARK

BRONZE

DARK

BRONZE

DARK

BRONZE

DARK

BRONZE

DARK

BRONZE

DARK

BRONZE

DARK

BRONZE

DARK

BRONZE

DARK

MOUNTING

14' POLE

ROUND

25' POLE

ROUND

25' POLE

ROUND

25' POLE

ROUND

MOUNTED

MOUNTED

MOUNTED

WALL

MOUNTED

MOUNTED

| WATTAGE | VOLTAGE

80

65

80

16

25

208


208

208

208

208

3 TYPICAL DECORATIVE POLE BASE DETAIL

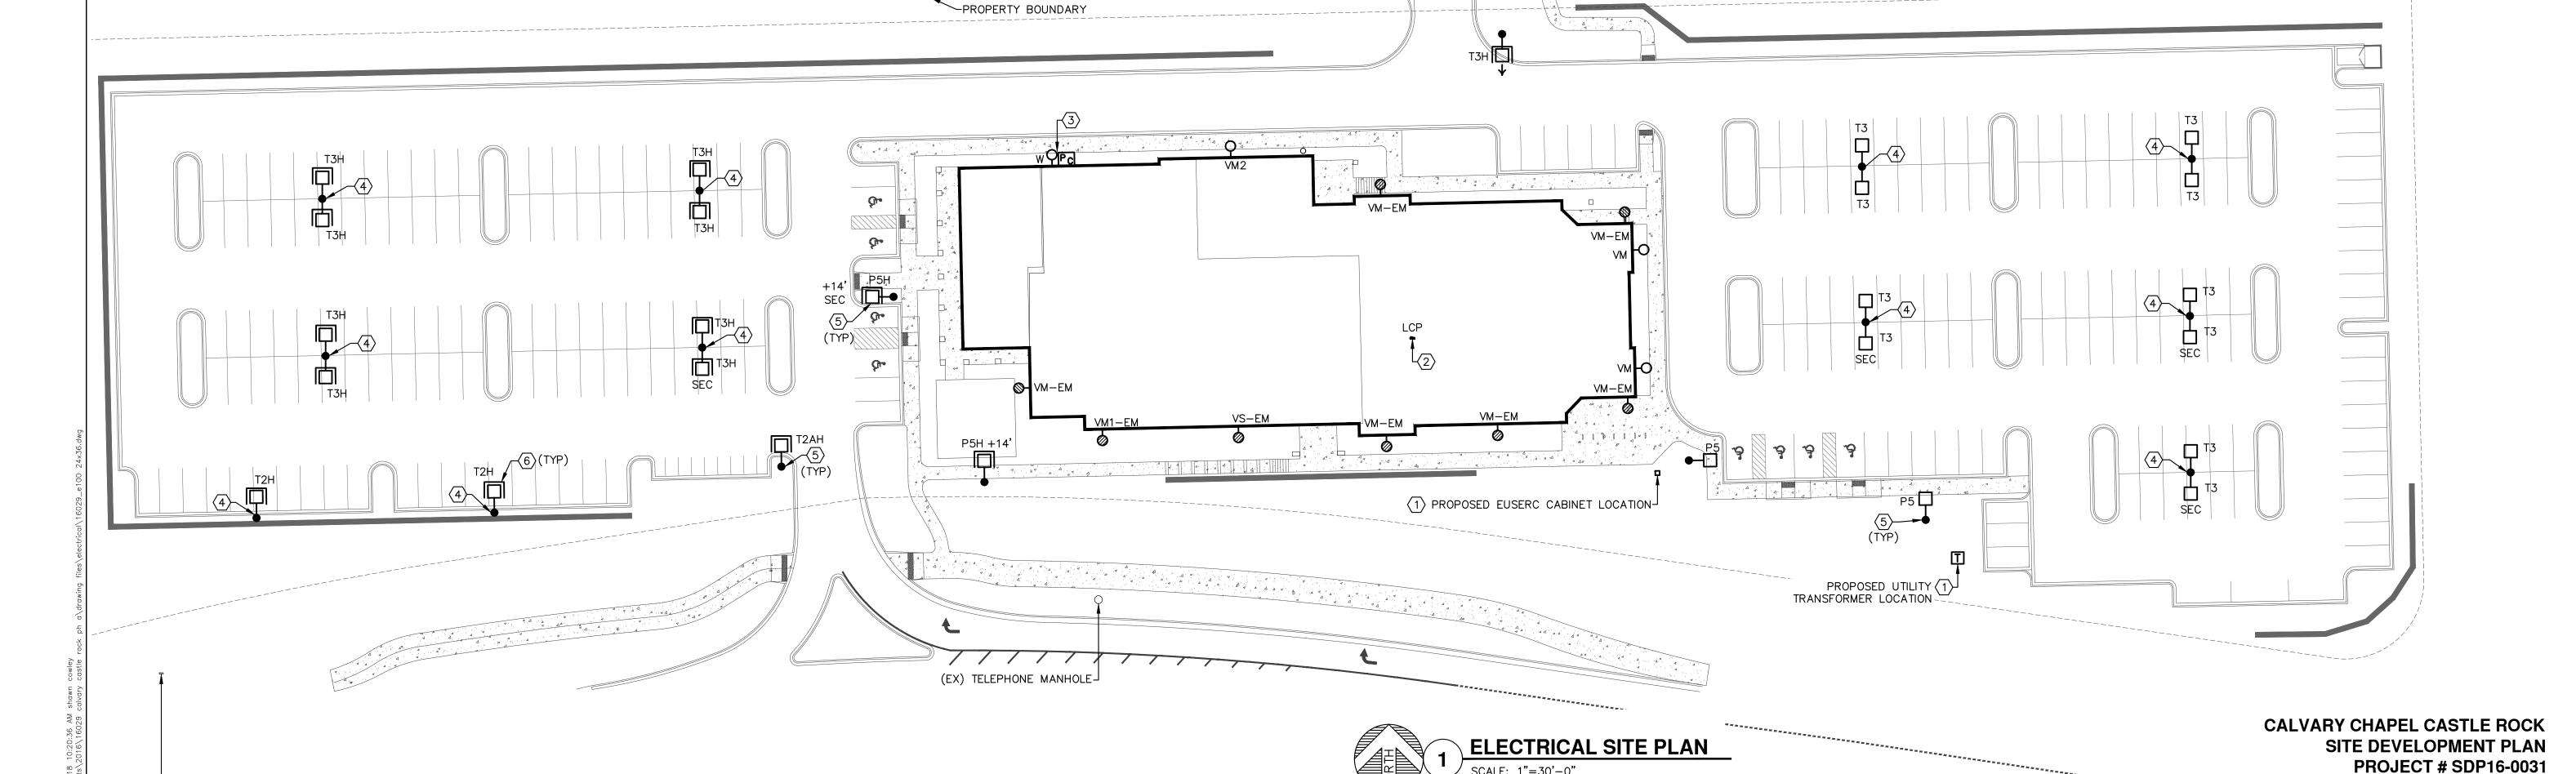

KEYED NOTES

- COORDINATE EXACT LOCATION WITH FIELD CONDITIONS AND WITH IREA. IREA REQUIRES UNRESTRICTED ACCESS (NO LOCKABLE ENTRY) TO EUSERC CABINET AND TRANSFORMER.
- LIGHTING CONTROL PANEL WITH TIME CLOCK,
 LITHIUM BATTERY BACK UP POWER SUPPLY AND
 ABILITY TO PROVIDE 50% DIMMING. VOLTAGE TO
 MATCH LIGHTING BEING CONTROLLED. LOCATE IN

STORAGE/MECHANICAL ROOM (NOT SHOWN).

- PHOTO CELL FOR CONTROLLING POLE LIGHTS AND EXTERIOR WALL-MOUNTED LIGHTS. COORDINATE EXACT LOCATION WITH FIELD
- 4 SEE TYPICAL POLE BASE DETAIL 2, THIS SHEET.
- SEE TYPICAL DECORATIVE POLE BASE DETAIL 3, THIS SHEET. TYPICAL FOR ALL LIGHT POLES NOT IN PARKING AREA.
- SYMBOL INDICATES ORIENTATION OF 270° HOUSE SIDE SHIELD (PARTIALLY BLOCKING LIGHT SOURCE FROM VIEWS TO THE WEST, NORTH, AND EAST.) TYPICAL FOR ALL FIXTURE TYPES ENDING IN 'H'.

CALVARY C PROPOSED NEW

O

 $\overline{\mathbf{0}}$

C

HUR

ELECTRICAL SITE PLAN

© COPYRIGHT 2017 ALL DRAWN & WRITTEN INFORMATION APPEARING HEREIN SHALL NOT BE DUPLICATED DISCLOSED OR OTHERWISE USED WITHOUT WRITTEN CONSENT OF PLANT ENGINEERING CONSULTANTS.

PROJECT 16029

DATE 06/21/2016

DRAWN JH/AO


CHECKED SC

E100

13 OF 14

LED

LOCATED IN THE SOUTHWEST 1/4 OF SECTION 1, TOWNSHIP 8 SOUTH, RANGE 67 WEST OF THE 6TH P.M. COUNTY OF DOUGLAS, STATE OF COLORADO

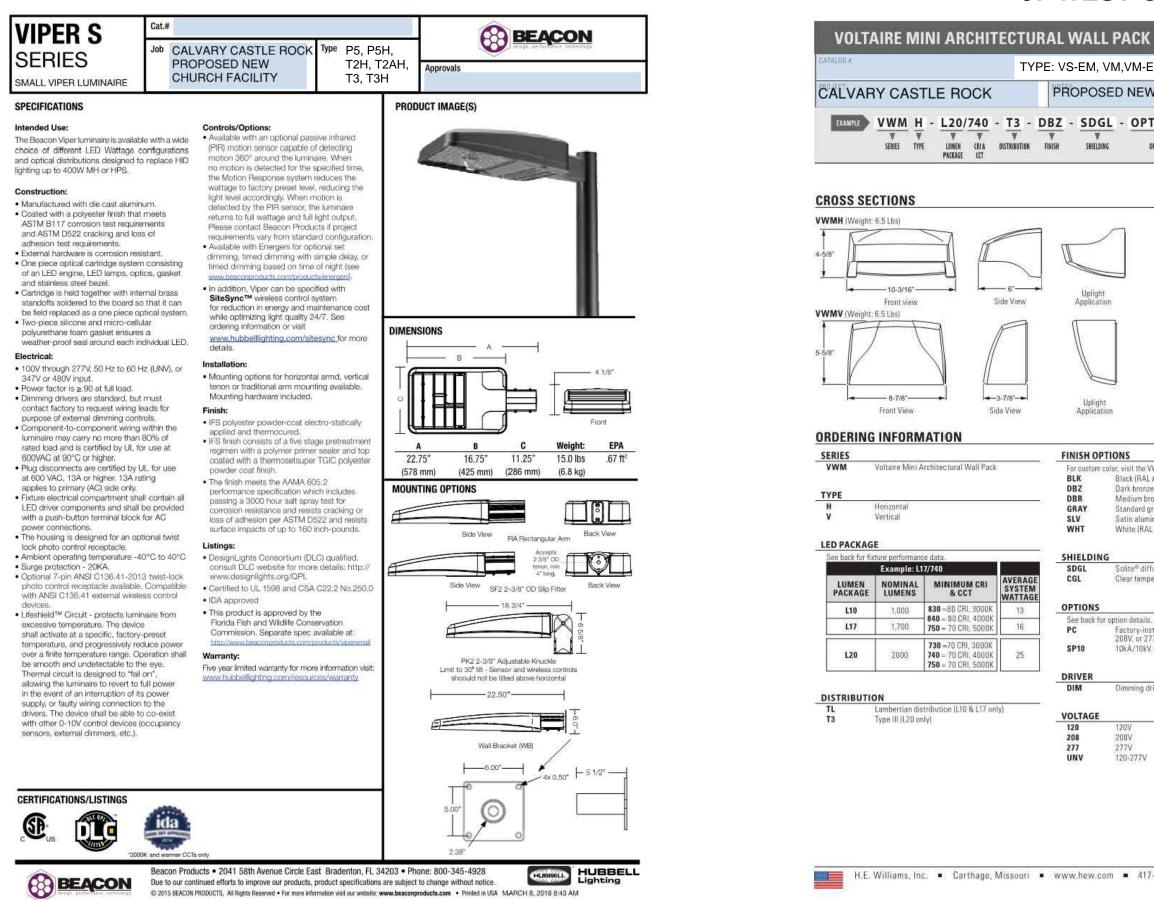

POLE MOUNTED LIGHT FIXTURE CUT SHEET

CALVARY CASTLE ROCK **CROSS SECTIONS FEATURE** GENERAL Engineered with the highest quality materials to ensure reliability, Provides security and accent lighting for walkways, entries, perimeters, and facades. Side View Intended for use in both uplight and downlight applications. Aesthetically designed horizontal and vertical housings bland seamlessly wit a variety of architectural styles Purposefully modeled to allow runoff of dirt and water for an always-clean Optional energy-saving photocell 8-7/8"----3-7/8"-Side View Rated >50,000 hours at 70% lumen ORDERING INFORMATION - ANSI 3000K, 4000K, or 5000K CCT Minimum 70 CRI. **FINISH OPTIONS** Available in six standard finish option This fixture is proudly made in the USA. Black (RAL #9004) THERMAL Integral die-cast aluminum heatsin provides optimal passive thermal Standard gray Concealed heatsink design preserves architectural appearance. White (RAL #9003) Rated ambient operating temperatur
 -30°C to 50°C (L10, L17), -30°C to 45°C OPTICAL Clear tempered glass lens Full cutoff, dark-sky compliant optics (downlight applications only) place lig where it's needed with minimal glare. 1,000 830 =80 CRI, 3000K 13 ELECTRICAL 10k A/10kV surge protection optional. 130 = 70 CRI, 4000K 750 = 70 CRI, 5000K 10kA/10kV surge protection Dimming driver prewired for 0-10V controls Lambertian distribution (L10 & L17 only) Type III (L20 only) H.E. Williams, Inc.
Carthage, Missouri
www.hew.com
417-358-4065 WALL MOUNTED LIGHT FIXTURE CUT SHEET

TYPE: VS-EM, VM,VM-EM, VM1-EM, VM2, W

ILLUMINANCE (FC) AVG/MIN RATIO = 6.13AVERAGE = 1.84MAX/MIN RATIO = 15.00MAXIMUM = 4.5MINIMUM = 0.3

WEST PARKING LOT SUMMARY:

OVERALL SUMMARY: ILLUMINANCE (FC) AVG/MIN RATIO = N/AAVERAGE = 0.9MAX/MIN RATIO = N/AMAXIMUM = 4.6MINIMUM = 0.0

EAST PARKING LOT SUMMARY: ILLUMINANCE (FC) AVG/MIN RATIO = 16.30AVERAGE = 1.63MAX/MIN RATIO = 38.00MAXIMUM = 3.8MINIMUM = 0.1

****DOOK CALVARY CHAPEL CASTLE ROCK**

SITE DEVELOPMENT PLAN

PROJECT # SDP16-0031

GENERAL NOTES

- A. THESE PHOTOMETRIC CALCULATIONS ARE BASED ON MANUFACTURER'S IES FILES AND A LIGHT LOSS FACTOR (LLF)
- ACTUAL ILLUMINANCE LEVELS MAY DIFFER FROM THE FOOTCANDLE LEVELS SHOWN DUE TO VARIABLE FIELD CONDITIONS, SUCH AS NEARBY EXISTING LUMINAIRES, LUMINAIRE DIRT DEPRECIATION, LANDSCAPING, AND FUTURE DEVELOPMENTS.
- C. OFF-SITE ILLUMINATION IS NOT PERMITTED.
- D. SEE ADDITIONAL GENERAL NOTES ON SHEET E100.

KEYED NOTES

- (1) COORDINATE EXACT LOCATION WITH FIELD CONDITIONS AND WITH IREA. IREA REQUIRES UNRESTRICTED ACCESS (NO LOCKABLE ENTRY) TO EUSERC CABINET AND TRANSFORMER.
- LIGHTING CONTROL PANEL WITH TIME CLOCK, LITHIUM BATTERY BACK UP POWER SUPPLY AND ABILITY TO PROVIDE 50% DIMMING. VOLTAGE TO MATCH LIGHTING BEING CONTROLLED. LOCATE IN
- STORAGE/MECHANICAL ROOM (NOT SHOWN). (3) PHOTO CELL FOR CONTROLLING POLE LIGHTS AND EXTERIOR WALL-MOUNTED LIGHTS. COORDINATE EXACT LOCATION WITH FIELD CONDITIONS.
- PROPOSED EUSERC CABINET LOCATION.
- PROPOSED UTILITY TRANSFORMER LOCATION.

O 80 C

PHOTOMETRIC SITE PLAN

 DATE
 06/21/2016

 DRAWN
 JH/AO

 CHECKED
 SC

E101

