PHILIP S MILLER LIBRARY SITE DEVELOPMENT PLAN


PURPOSE STATEMENT:

THE PURPOSE OF THIS SITE DEVELOPMENT PLAN IS TO REDEVELOP THE EXISTING PHILIP S MILLER LIBRARY IN DOWNTOWN CASTLE ROCK, COLORADO. THE EXISTING LIBRARY IS TO BE DEMOLISHED AND A NEW LIBRARY FACILITY WILL BE CONSTRUCTED WITH NEW INFRASTRUCTURE, PAVING, PEDESTRIAN WALKWAYS AND PLAZA AREAS.

LEGAL DESCRIPTION:

THAT PART OF BLOCK 1. FIRST AMENDED PLAT OF CASTLE PLAZA SUBDIVISION LYING NORTH OF A LINE 328.00 FEET SOUTH OF AND PARALLEL WITH THE NORTH LINE OF SAID BLOCK 1, EXCEPT THE NORTH 50 FEET THEREOF. SAID NORTH 50 FEET BEING MEASURED AT RIGHT ANGLES TO SAID NORTH LINE, ALSO EXCEPTING THEREFROM THAT PORTION AS CONVEYED TO THE CITY OF CASTLE ROCK IN INSTRUMENT RECORDED FEBRUARY 11, 1982 IN BOOK 434 AT PAGE 409, COUNTY OF DOUGLAS, STATE OF COLORADO.

	Zoning Comparison		
Zoning District	B - Business Commercial		
Overlay District	DOD - Downtown Overlay District		
DOD Area	South		
Downtown Parking Area	Souti	n Non-Residential	
	Requirement	Provided (this SDP)	
Permitted Use	Office, service, retail, restaurant, public facility, and other uses as outlined for the B and DOD districts per Muni. Code 17.28.030	Library	
Minimum Lot Size SF/Acres	N/A	151,338 SF/ 3.47 Acres	
Gross Floor Area (GFA)	N/A	62,738 SF	
Building Ground Coverage	N/A	30,780 SF	
Maximum Lot Coverage	100%	20% (30,780/151,338)	
Minimum front yard setback	0-Feet	9-Feet (Wilcox)	
Minimum rear yard setback	0-Feet	270-Feet (east)	
Minimum side vard setback	0-Feet	78-Feet (south)	
Maximum building setback to roadway	20-Feet. A minimum of 25% of a building's linear footage facing a public roadway must have a setback of 0- to 20-feet with a direct pedestrian connection	36% of the building facing Wilcox St. is within 20- feet of Wilcox St. and provides a direct pedestrian connection; 0%* of the building facing Phelps St. is within 20-feet of Phelps St. and provides a direct pedestrian connection	
Maximum Stories	6 Stories	2 Stories	
Maximum building height	Not Limited	34 Feet	
Minimum Parking	For Library - 2 parking spaces per 1,000 SF of GFA	Total parking spaces provided = 206 Total parking spaces required = 126 (62,738/1,000) x 2 = 126	
Minimum ADA Parking	7 ADA parking spaces required for 201- 300 total lot parking spaces per Muni Code	ADA parking spaces provided = 7 ADA parking spaces required = 7 Total lot spaces = 206	
Minimum Bicycle Parking	5% of total parking spaces provided	Bicycle parking spaces provided = 16 Bicycle parking spaces required = 11 206 x 5% = 10.3	
Minimum Window Transparency at	35% for the main front elevation	69% for Wilcox Street (114' / 165') Total window or transparency = 114' (102' + 12') Total building length = 165'	
the pedestrian level	30% for a side elevation that faces a public roadway	30.7% for Phelps Street (47' 2"/153') Total window or transparency = 47' 2" (8' 3" + 3' + 22' 6" + 13' 5") Total building length = 153' (88' + 65')	

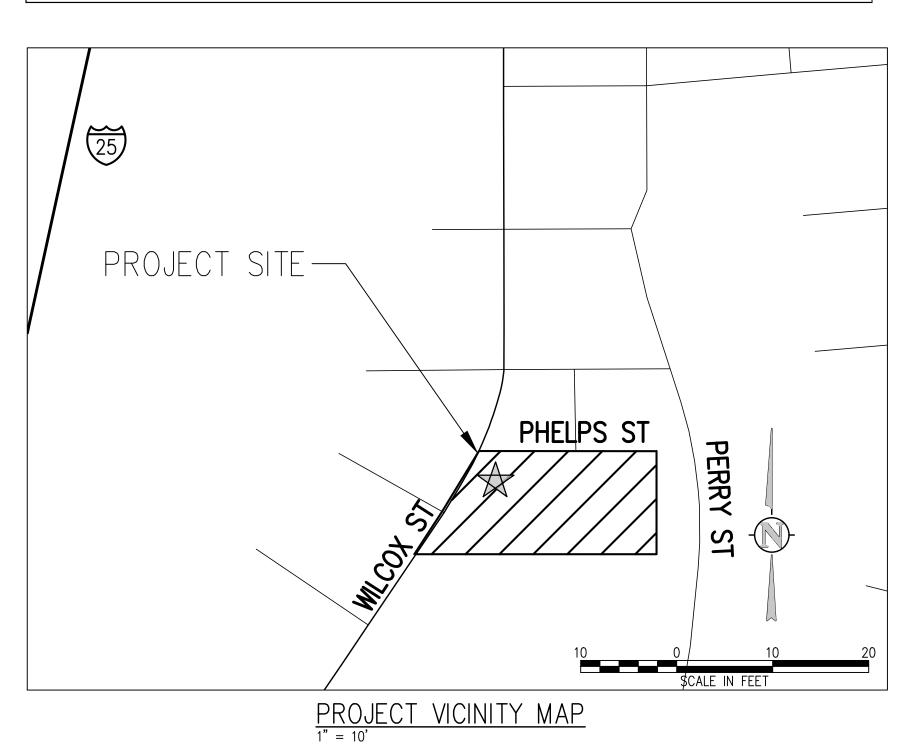

WATER RIGHTS DEDICATION AGREEMENT TITLE CERTIFICATION DESIGN REVIEW BOARD APPROVAL WATER RIGHTS DEDICATION: THIS SITE DEVELOPMENT PLAN WAS APPROVED BY THE DESIGN REVIEW BOARD ____, AN AUTHORIZED REPRESENTATIVE OF THE TOWN OF CASTLE ROCK HAS ACQUIRED CONTROL OF THE WATER RIGHTS THROUGH THE ADOPTION OF ORDNANCE NO. 97-17 AND PURSUANT TO THE , A TITLE INSURANCE COMPANY LICENSED TO DO BUSINESS IN THE STATE OF COLORADO, HAVE MADE IMPLIED CONSET PROVISION OF C.R.S 37-90-137(8). AN EXAMINATION OF THE PUBLIC RECORDS AND STATE THAT ALL OWNERS, MORTGAGEES AND LIENHOLDERS OF THE PROPERTY ARE LISTED IN THE CERTIFICATE OF OWNERSHIP AND LIENHOLDER SUBORDINATION CERTIFICATE. SURVEYOR'S CERTIFICATE __, A REGISTERED AUTHORIZED REPRESENTATIVE PROFESSIONAL LAND SURVEYOR IN THE STATE OF COLORADO, DO HEREBY S CERTIFICATE CERTIFY THAT THE SURVEY AND LEGAL DESCRIPTION REPRESENTED BY THIS SITE DEVELOPMENT PLAN WAS MADE UNDER MY SUPERVISION AND THE MONUMENTS THIS SITE DEVELOPMENT PLAN WAS FILED FOR RECORD IN THE OFFICE OF THE TITLE COMPANY SHOWN THEREON ACTUALLY EXIST AND THIS SITE DEVELOPMENT PLAN COUNTY CLERK AND RECORDER OF DOUGLAS COUNTY AT _____ ON ACCURATELY REPRESENTS THAT SURVEY. THE _____ DAY OF SIGNED THIS _____, 20_____, 20_____, DATE REGISTERED LAND SURVEYOR DOUGLAS COUNTY CLERK AND RECORDER NOTARY BLOCK CIVIL ENGINEER'S STATEMENT BY: ____ SUBSCRIBED AND SWORN TO BEFORE ME THIS _____ DAY OF_____, DEPUTY , BEING A REGISTERED 20_____ BY ____ PROFESSIONAL ENGINEER IN THE STATE OF COLORADO, HEREBY ATTEST THAT AUTHORIZED REPRESENTATIVE ALL ROADWAY, GRADING, UTILITY AND DRAINAGE IMPROVEMENTS IDENTIFIED ON THIS SITE DEVELOPMENT PLAN HAVE BEEN DESIGNATED AND ENGINEERED IN CONFORMANCE WITH ALL TOWN OF CASTLE ROCK PUBLIC WORKS CONSTRUCTION STANDARDS. WITNESS MY HAND AND OFFICIAL SEAL. REGISTERED PROFESSIONAL ENGINEER DATE NOTARY PUBLIC MY COMMISSION EXPIRES: _____. BENCHMARK INFORMATION: A GPS DERIVED ELEVATION WAS ESTABLISHED AT AN ONSITE BENCHMARK AT THE SOUTHEAST CORNER OF LOT 2, BEING A FOUND #5 REBAR WITH AN ELEVATION OF 6213.58 FEET. A CHECK SHOT, 0.1'±, WAS TAKEN ON NGS POINT G 23, BEING A BENCHMARK DISK LOCATED 0.1 MILES FROM SITE, WITH A PUBLISHED ELEVATION OF 6231.61 FEET (NAVD88). NO DIFFERENTIAL LEVELING WAS PERFORMED TO ESTABLISH

THIS ELEVATION.

A PORTION OF BLOCK 1, FIRST AMENDED PLAT OF CASTLE PLAZA SUBDIVISION, LOT 2, CASTLE PLAZA SOUTH - FIRST AMENDMENT LOCATED IN THE SOUTHWEST QUARTER OF SECTION 11 TOWNSHIP 8 SOUTH, RANGE 67 WEST OF THE 6TH P.M., TOWN OF CASTLE ROCK, COUNTY OF DOUGLAS, STATE OF COLORADO

SHEET LIST SCHEDULE

SHEET NO.	TITLE
1	COVER
2	ABBREVIATIONS, SYMBOLS, AND LEGEND
3	TOWN OF CASTLE ROCK SDP GENERAL NOTES
4	SITE PLAN
5	PHASING PLAN I
6	PARKING PLAN
7	GRADING PLAN
8	UTILITY PLAN
9	LANDSCAPE PLAN – HARDSCAPE
10	LANDSCAPE PLAN
11	LANDSCAPE SUMMARY, NOTES & DETAILS
12	BUILDING ELEVATIONS 1
13	BUILDING ELEVATIONS 2
14	BUILDING ELEVATIONS 3
15	MATERIALS BOARD
16	LIGHTING PLAN
17	LIGHTING SCHEDULE AND FIXTURE CUT SHEETS

BASIS OF BEARINGS: S89'49'59"E 633.38' (AM), S89'23'09"E 633.38'

OF THE TOWN OF CASTLE ROCK, COLOF , 2021	5
CHAIR D	A
DIRECTOR OF DEVELOPMENT SERVICES	
DOUGLAS COUNTY CLERK AND RECORDER	ę

_____, 20_____ AT RECEPTION NO.

RADO ON THE _____ DAY OF ____

DATE



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Owner **Douglas County Libraries** 100 S. Wilcox St Castle Rock, CO 80104

Project Castle Rock Library 100 S. Wilcox St Castle Rock, CO 80104

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Electrical Engineer

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Cevian 7535 E. Hampden Ave. #400 Denver, CO 80231 P. 720-723-0328

Revision Description

OPN Project No. 21212000

Sheet Issue Date SDP SUBMISSION 5

1/12/2022

Sheet Name

5-SDP21-0042 COVER

Sheet Number

ABBREVIATIONS

AASHTO ABAN AC ADDL ADDM ADJ AL ALT	AMERICAN ASSOC. OF STATE HIGHWAY AND TRANSPORTATION OFFICIALS ABANDON ASPHALTIC CONCRETE PAVING ADDITIONAL ADDENDUM ADJUSTABLE ALUMINUM ALTERNATE	INCL ID IN INSUL INV IRR JTS	INCLUDED INSIDE DIAMETER INLET INSULATION INVERT IRRIGATION JOINTS
AMT APPROX ARCH	AMOUNT APPROXIMATE ARCHITECT(URAL)	KO KPL KWY	KNOCKOUT KICK PLATE KEYWAY
ARV ASTM ASPH ASSY ASYM AUTO AVG	AIR RELIEF VALVE AMERICAN SOCIETY FOR TESTING AND MATERIALS ASPHALT ASSEMBLY ASYMMETRICAL AUTOMATIC AVERAGE	L LSCAPE LF LP LT LWL	LEFT OR LITER LANDSCAPE(ING) LINEAR FOOT LOW POINT LIGHT LOW WATER LEVEL
AWWA BC BFV BG BLDG BLK BM BMP BS BOS	AMERICAN WATER WORKS ASSOC. BACK OF CURB BUTTERFLY VALVE FINISHED GRADE ADJACENT TO BOTTOM OF WALL BUILDING BLOCK BENCH MARK BEST MANAGEMENT PRACTICE BACKSIGHT BOTTOM OF STEP	MAINT MAN MATL MAX ME MECH MFR MH MIN MISC	MAINTENANCE MANUAL MATERIAL MAXIMUM MATCH EXISTING MECHANICAL MANUFACTURER MANHOLE MINIMUM MISCELLANEOUS
BOT BSMT BVCE BVCS BW CB	BOTTOM BASEMENT BEGIN VERTICAL CURVE ELEVATION BEGIN VERTICAL CURVE STATION BOTTOM OF WALL CATCH BASIN	MJ NA NIC NPT	MECHANICAL JOINT NORTH NOT APPLICABLE NOT IN CONTRACT NATIONAL PIPE THREAD
CD CCW CDOT CIP CJ CL CLR	COUNTER CLOCKWISE COLORADO DEPARTMENT OF TRANSPORTATION CAST IRON PIPE CONSTRUCTION JOINT CENTER LINE OR CHAIN LINK CLEAR	NTS OC OD OPP OPT	NOT TO SCALE ON CENTER OUTSIDE DIAMETER OPPOSITE OPTIONAL
CMP CMU CO CONC CONST CONT COR CR	CORRUGATED METAL PIPE CONCRETE MASONRY UNIT CLEANOUT CONCRETE CONSTRUCTION CONTINUOUS(ATION) CORNER CONCENTRIC REDUCER	PC PCO PCR PI PVI PL PE PREFAB	POINT OF CURVATURE PRESSURE CLEAN OUT POINT OF CURVE RETURN POINT OF INTERSECTION POINT OF VERTICAL INTERSECTION PROPERTY LINE POLYETHYLENE PREFABRICATED
CTR CY DEMO DIA DIAG DIP	CENTER CUBIC YARDS DEMOLITION DIAMETER DIAGONAL DUCTILE IRON PIPE	PRELIM PREP PROP PRV PSF PSI	PRELIMINARY PREPARATION PROPOSED PRESSURE REDUCING VALVE OR PRESSURE RELIEF VALVE POUNDS PER SQUARE FOOT POUNDS PER SQUARE INCH
DOM DN DR DWG DWL	DOMESTIC DOWN DRAIN DRAWING DOWEL	PT PV PVC PVMT	POINT OF TANGENCY PLUG VALVE POLYVINYL CHLORIDE OR POINT OF VERTICAL CURVATURE PAVEMENT
E EA ECC	EAST EACH ECCENTRIC	QTY R	QUANTITY
EA ECC EJ EL ELB	EACH ECCENTRIC EXPANSION JT ELEVATION ELBOW	R RAD RCP RD	RIGHT RADIUS REINFORCED CONCRETE PIPE ROOF DRAIN
EA ECC EJ EL ELB ELEC ENGR EOP EQ	EACH ECCENTRIC EXPANSION JT ELEVATION ELBOW ELECTRICAL ENGINEER EDGE OF PAVEMENT EQUAL	R RAD RCP RD RE RECT REINF REQD	RIGHT RADIUS REINFORCED CONCRETE PIPE ROOF DRAIN REFERENCE RECTANGULAR REINFORCE (D) (ING) (MENT) REQUIRED
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YARD HYDRANT

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	TYPE 13 FIELD INLET	52	EXIST INDEX CONTOUR
	FLARED END SECTION W/ RIPRAP	20	
F	TEE W/ THRUST BLOCK	227	EXIST INTERMEDIATE CONTOUR
L	BEND W/ THRUST BLOCK	20	PROPOSED INDEX CONTOUR
	END CAP W/ THRUST BLOCK		PROPOSED INTERMEDIATE CONTOUR
	GATE VALVE		PROFUSED INTERMEDIATE CONTOUR
Ø	REDUCER/INCREASER WATER METER		CURB AND GUTTER
Č.	FIRE HYDRANT	►	SPILL/CATCH CURB TRANSITION
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	STORM – LARGER THAN 12"		CURB RAMP
RD	- ROOF DRAIN		Know what's Delow.
TD	- TRENCH DRAIN		SIDEWALK CHASE Call before you
UD	- UNDERDRAIN		
SS	- SANITARY SEWER		SIDEWALK
FM	-	A 4	CONCRETE PAVING
WW	-		HEAVY DUTY CONCRETE PAVING
NP₩	-		HEAVY DUTY ASPHALT PAVING
PW			
IRR	- IRRIGATION		LIGHT DUTY ASPHALT PAVING
CATV	 IRRIGATION – LARGER THAN 12" CABLE TV 		GRAVEL
D	-		PROPOSED BUILDING
Е	- ELECTRIC		
UE	- UNDERGROUND ELECTRIC		BUILDING ACCESS
OE	- OVERHEAD ELECTRIC		RETAINING WALL
T	- TELEPHONE		•
F0	- FIBER OPTIC		LIMITS OF SAWCUT
FUEL	-		LIMITS OF WORK
G	-		EASEMENT LINE
PVC	-		PROPERTY LINE

<u>DETAIL TITLE</u>

DETAIL TITLE SCALE


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SECTION CALLOUT

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Date

Revision Description

OPN Project No. 21212000

SDP SUBMISSION 5 1/12/2022 Sheet Name

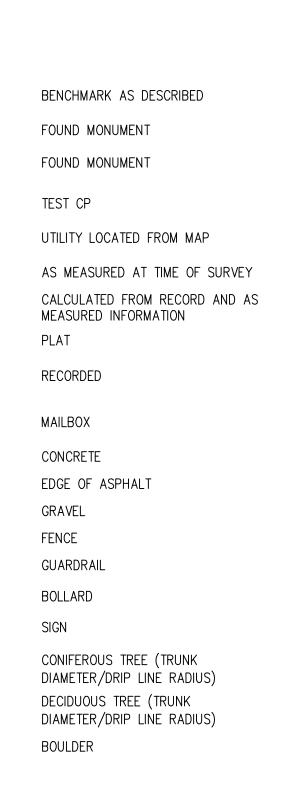Sheet Issue Date

1-SDP21-0042 ABBREVIATIONS, SYMBOLS, AND LEGEND Sheet Number

SITE DEVELOPMENT PLAN GENERAL NOTES

- 1. THE TOWN OF CASTLE ROCK REQUIRES THAT MAINTENANCE ACCESS BE PROVIDED TO ALL STORM DRAINAGE FACILITIES TO ASSURE CONTINUOUS OPERATIONAL CAPABILITY OF THE SYSTEM. THE PROPERTY OWNER, SUBSEQUENT OWNERS, HEIRS, SUCCESSORS AND ASSIGNS SHALL BE RESPONSIBLE FOR THE MAINTENANCE OF ALL DRAINAGE FACILITIES INCLUDING, BUT NOT LIMITED TO, INLETS, PIPES, CULVERTS, CHANNELS, DITCHES, HYDRAULIC STRUCTURES, AND DETENTION BASINS LOCATED ON THIS PROPERTY, UNLESS MODIFIED BY THE SUBDIVISION IMPROVEMENTS AGREEMENT. SHOULD THE OWNER FAIL TO ADEQUATELY MAINTAIN SAID FACILITIES, THE TOWN SHALL HAVE THE RIGHT TO ENTER SAID PROPERTY FOR THE PURPOSES OF OPERATION AND MAINTENANCE. ALL SUCH MAINTENANCE COSTS WILL BE ASSESSED TO THE PROPERTY OWNER, SUBSEQUENT OWNERS, HEIRS, SUCCESSORS AND ASSIGNS. THE MAINTENANCE COSTS SHALL INCLUDE ALL ACTUAL COSTS FOR LABOR, EQUIPMENT AND MATERIALS AND A 25% FEE.
- PURSUANT TO SECTION 4.7 AND 9.32 OF THE TOWN OF CASTLE ROCK LANDSCAPE REGULATIONS THE PROPERTY OWNER, SUBSEQUENT OWNERS, HEIRS, SUCCESSORS AND ASSIGNS SHALL 2. BE RESPONSIBLE FOR THE PROPER MAINTENANCE OF THE AREA SUBJECT TO THE APPROVED SITE DEVELOPMENT PLAN. LANDSCAPING WITHIN PUBLIC RIGHTS-OF-WAY IS TO BE MAINTAINED BY THE ADJACENT PRIVATE PROPERTY OWNER OR THE HOMEOWNER/PROPERTY OWNER ASSOCIATION, AS APPLICABLE. LANDSCAPING SHALL BE CONTINUOUSLY MAINTAINED INCLUDING NECESSARY WATERING, WEEDING, PRUNING, MOWING, PEST CONTROL, AND REPLACEMENT OF DEAD OR DISEASED PLANT MATERIAL. UPON WRITTEN NOTICE BY THE TOWN, THE OWNER WILL HAVE 45 DAYS TO CURE OR REPLACE DAMAGED OR DEAD LANDSCAPE MATERIAL. IN THE CASE OF DISEASED LANDSCAPE MATERIAL, A SHORTER COMPLIANCE PERIOD MAY BE SPECIFIED IN SAID NOTICE. THE TOWN OF CASTLE ROCK WATER CONSERVATION ORDINANCE REGULATES TIMES OF SEASONAL IRRIGATION AND PROHIBITS THE WASTING OF POTABLE WATER THROUGH IMPROPER IRRIGATION.
- 3. THE PROVIDED LANDSCAPE COUNTS IN THE SITE DEVELOPMENT PLAN ARE MINIMUM REQUIRED COUNTS. ANY CHANGES TO THE PROVIDED LANDSCAPE COUNTS SHALL REQUIRE AN SDP AMENDMENT. THE LOCATION OF PLANT MATERIAL IS SUBJECT TO CHANGE DUE TO FIELD CONDITIONS WITH REVIEW OF THE CONSTRUCTION DOCUMENTS.
- 4. THIS PROPERTY IS LOCATED WITHIN ZONE X SHADED AND UNSHADED, AS PER FEMA FIRM PANEL NO. 08035C0301G DATED MARCH 16, 2016. THIS AREA IMPACTS ONLY THE SOUTHWEST PORTION OF THE SITE AT THE WILCOX ACCESS POINT.
- 5. ANY STREET SIGNS, STRIPING, STREETLIGHTS AND CURB RAMPS ARE CONCEPTUAL ONLY AND SUBJECT TO TOWN REVIEW WITH THE CONSTRUCTION DOCUMENTS. THESE ITEMS SHALL COMPLY WITH THE TOWN OF CASTLE ROCK'S REGULATIONS, STANDARDS AND REQUIREMENTS.
- 6. THE DEVELOPER SHALL CONFORM TO THE TOWN OF CASTLE ROCK "WATER USE MANAGEMENT PROGRAM IMPLEMENTATION POLICY", AS AMENDED FROM TIME TO TIME, FOR THIS PROJECT. 7 APPROVAL OF THIS SITE DEVELOPMENT PLAN DOES NOT CONSTITUTE APPROVAL OF ANY DEVIATIONS FROM TOWN OF CASTLE ROCK REGULATIONS AND STANDARDS. ALL DEVIATIONS FROM TOWN REGULATIONS AND STANDARDS ARE SUBJECT TO THE APPROPRIATE PROCEDURES FOR APPROVAL.
- 8. NO SOLID OBJECT (EXCLUDING FIRE HYDRANTS, TRAFFIC CONTROL DEVICES AND TRAFFIC SIGNS) EXCEEDING THIRTY (30) INCHES IN HEIGHT ABOVE THE FLOWLINE ELEVATIONS OF THE ADJACENT STREET, INCLUDING BUT NOT LIMITED TO BUILDINGS, UTILITY CABINETS, WALLS, FENCES, LANDSCAPE PLANTINGS, CROPS, CUT SLOPES, AND BERMS SHALL BE PLACED WITHIN SIGHT DISTANCE LINES AND SIGHT DISTANCE EASEMENTS.
- 9. ALL UTILITY, DRAINAGE, EMERGENCY ACCESS, SIGHT DISTANCE AND PUBLIC ACCESS/TRAIL EASEMENTS AS SHOWN ON THE SITE DEVELOPMENT PLAN SHALL BE GRANTED TO THE TOWN OF CASTLE ROCK BY SEPARATE DOCUMENT.
- 10. THIS SITE IS ZONED BUSINESS/COMMERCIAL (B) WITHIN THE DOWNTOWN OVERLAY DISTRICT (DOD)
- 11. ALL EMERGENCY ACCESS ROADS, EMERGENCY ACCESS GATES AND SIGNAGE SHALL COMPLY WITH THE TOWN OF CASTLE ROCK FIRE DEPARTMENT REQUIREMENTS AND SHALL BE MAINTAINED BY METROPOLITAN DISTRICT, HOMEOWNERS ASSOCIATION, OR OTHER PROPERTY MANAGEMENT ENTITY. 12. UNLESS OTHERWISE NOTED, ALL LOTS SHALL HAVE A 10-FOOT UTILITY EASEMENT ALONG THE FRONT AND REAR LOT LINES AND ALONG ALL PUBLIC RIGHTS-OF-WAY AND SHALL HAVE
- 5-FOOT UTILITY EASEMENTS ALONG EACH SIDE LOT LINE. THESE UTILITY EASEMENTS ARE FOR THE INSTALLATION, MAINTENANCE AND OPERATION OF UTILITIES AND DRAINAGE FACILITIES INCLUDING, BUT NOT LIMITED TO STREET LIGHTS, ELECTRIC LINES, GAS LINES, CABLE TELEVISION LINES, FIBER OPTIC LINES AND TELEPHONE LINES, AS WELL AS PERPETUAL RIGHT FOR INGRESS AND EGRESS FOR INSTALLATION. MAINTENANCE AND REPLACEMENT OF SUCH LINES.
- 13. RETAINING WALLS, SECTIONS OF RETAINING WALLS GREATER THAN 4-FEET IN HEIGHT AS MEASURED FROM THE BOTTOM OF THE FOOTING TO THE TOP OF THE WALL, AND RETAINING WALLS, REGARDLESS OF HEIGHT, WHICH RETAIN A SURCHARGE OR TIERED WALLS MUST BE DESIGNED BY A STRUCTURAL ENGINEER LICENSED IN THE STATE OF COLORADO AND MUST RECEIVE A BUILDING PERMIT FROM THE TOWN OF CASTLE ROCK.
- 14. A SIGN PERMIT FOR EACH SIGN MUST BE OBTAINED FROM THE TOWN OF CASTLE ROCK BUILDING DIVISION PRIOR TO PLACING ANY SIGN ON THE PROPERTY. ALL SIGNS MUST COMPLY WITH THE PROVISIONS OF TITLE 19 (SIGN CODE REGULATIONS) OF THE MUNICIPAL CODE.
- 15. THE NUMBER OF PARKING SPACES HAS BEEN SET BASED ON THE PROPOSED USES ON THIS SITE DEVELOPMENT PLAN AND CHAPTER 17.54 OF THE CASTLE ROCK MUNICIPAL CODE. A CHANGE OF USE TO A MORE PARKING INTENSIVE USE AS IDENTIFIED IN CHAPTER 17.54 OF THE CASTLE ROCK MUNICIPAL CODE WILL REQUIRE AN AMENDMENT TO THIS SITE DEVELOPMENT PLAN.

FIRE NOTES

- 1. IF FIRE APPARATUS ACCESS ROADS OR WATER SUPPLY FOR FIRE PROTECTION IS REQUIRED TO BE INSTALLED, SUCH PROTECTION SHALL BE INSTALLED AND MADE SERVICEABLE PRIOR TO VERTICAL CONSTRUCTION.
- 2. FIRE HYDRANT(S) ARE REQUIRED TO BE INSTALLED AND MADE SERVICEABLE PRIOR TO AND DURING THE TIME OF CONSTRUCTION.
- 3. APPROVED FIRE APPARATUS ACCESS ROADS SHALL BE PROVIDED FOR EVERY FACILITY, BUILDING OR PORTION OF A BUILDING CONSTRUCTED OR MOVED INTO, OR WITHIN THE JURISDICTION. THE FIRE APPARATUS ACCESS ROAD SHALL EXTEND TO WITHIN 150 FEET OF ALL PORTIONS OF THE FACILITY AND ALL PORTIONS OF THE EXTERIOR WALLS OF THE FIRST STORY OF THE BUILDING AS MEASURED BY AN APPROVED ROUTE AROUND THE EXTERIOR OF THE BUILDING OR FACILITY.
- 4. DEAD-END FIRE ACCESS ROADS IN EXCESS OF 150 FEET SHALL PROVIDE AN APPROVED AREA FOR TURNING AROUND FIRE APPARATUS.
- 5. FIRE APPARATUS ACCESS ROADS SHALL HAVE AN UNOBSTRUCTED WIDTH OF NOT LESS THAN 20 FEET, EXCLUSIVE OF SHOULDERS, EXCEPT FOR APPROVED SECURITY GATES AND AN UNOBSTRUCTED VERTICAL CLEARANCE OF NOT LESS THAN 13 FEET, 6 INCHES.
- 6. FIRE APPARATUS ACCESS ROADS SHALL BE DESIGNED AND MAINTAINED TO SUPPORT THE IMPOSED LOADS OF FIRE APPARATUS WEIGHING AT LEAST 75,000 POUNDS, AND SHALL BE SURFACED SO AS TO PROVIDE ALL-WEATHER DRIVING CAPABILITIES. THE TERM "ALL-WEATHER DRIVING CAPABILITIES" HAS BEEN INTERPRETED TO MEAN EITHER CONCRETE OR ASPHALT, OR OTHER APPROVED DRIVING SURFACE DESIGNED BY AN ENGINEER AND APPROVED BY THE FIRE DEPARTMENT.
- "NO PARKING FIRE LANE" SIGNS ARE REQUIRED IN AREAS THAT MEET THE FOLLOWING CRITERIA AND IN AREAS DESIGNATED BY THE FIRE PREVENTION BUREAU. SIGNS SHALL BE POSTED ON 7. BOTH SIDES OF FIRE ACCESS ROADWAYS, PUBLIC OR PRIVATE ROADWAYS AND DRIVEWAYS LESS THAN 26 FEET WIDE. SIGNS SHALL BE POSTED ON ONE SIDE ONLY OF FIRE ACCESS ROADWAYS, PUBLIC OR PRIVATE ROADWAYS OR DRIVEWAYS BETWEEN 26 FEET WIDE AND 32 FEET WIDE. NO SIGNAGE IS REQUIRED FOR FIRE ACCESS ROADWAYS, PUBLIC OR PRIVATE ROADWAYS OR DRIVEWAYS GREATER THAN OR EQUAL TO32 FEET WIDE.
- 8. IT IS THE RESPONSIBILITY OF THE PROPERTY OWNER TO MAINTAIN DRIVE LANES FOR EMERGENCY VEHICLE INGRESS AND EGRESS, INCLUDING SNOW REMOVAL. 9. THE DEVELOPER UNDERSTANDS THAT AS THE PROJECT DEVELOPS THERE MAY BE FIRE AND LIFE SAFETY PROVISIONS OF THE TOWN OF CASTLE ROCK ADOPTED INTERNATIONAL FIRE CODE (IFC) THAT MAY ARISE, AND WERE NOT CLEARLY VISIBLE DURING THE INITIAL REVIEWS, BUT MAY REQUIRE CORRECTIVE ACTION. THESE ITEMS MAY INCLUDE, BUT ARE NOT LIMITED TO: FIRE FLOW REQUIREMENTS. FIRE HYDRANT PLACEMENT. ACCESS. ETC.

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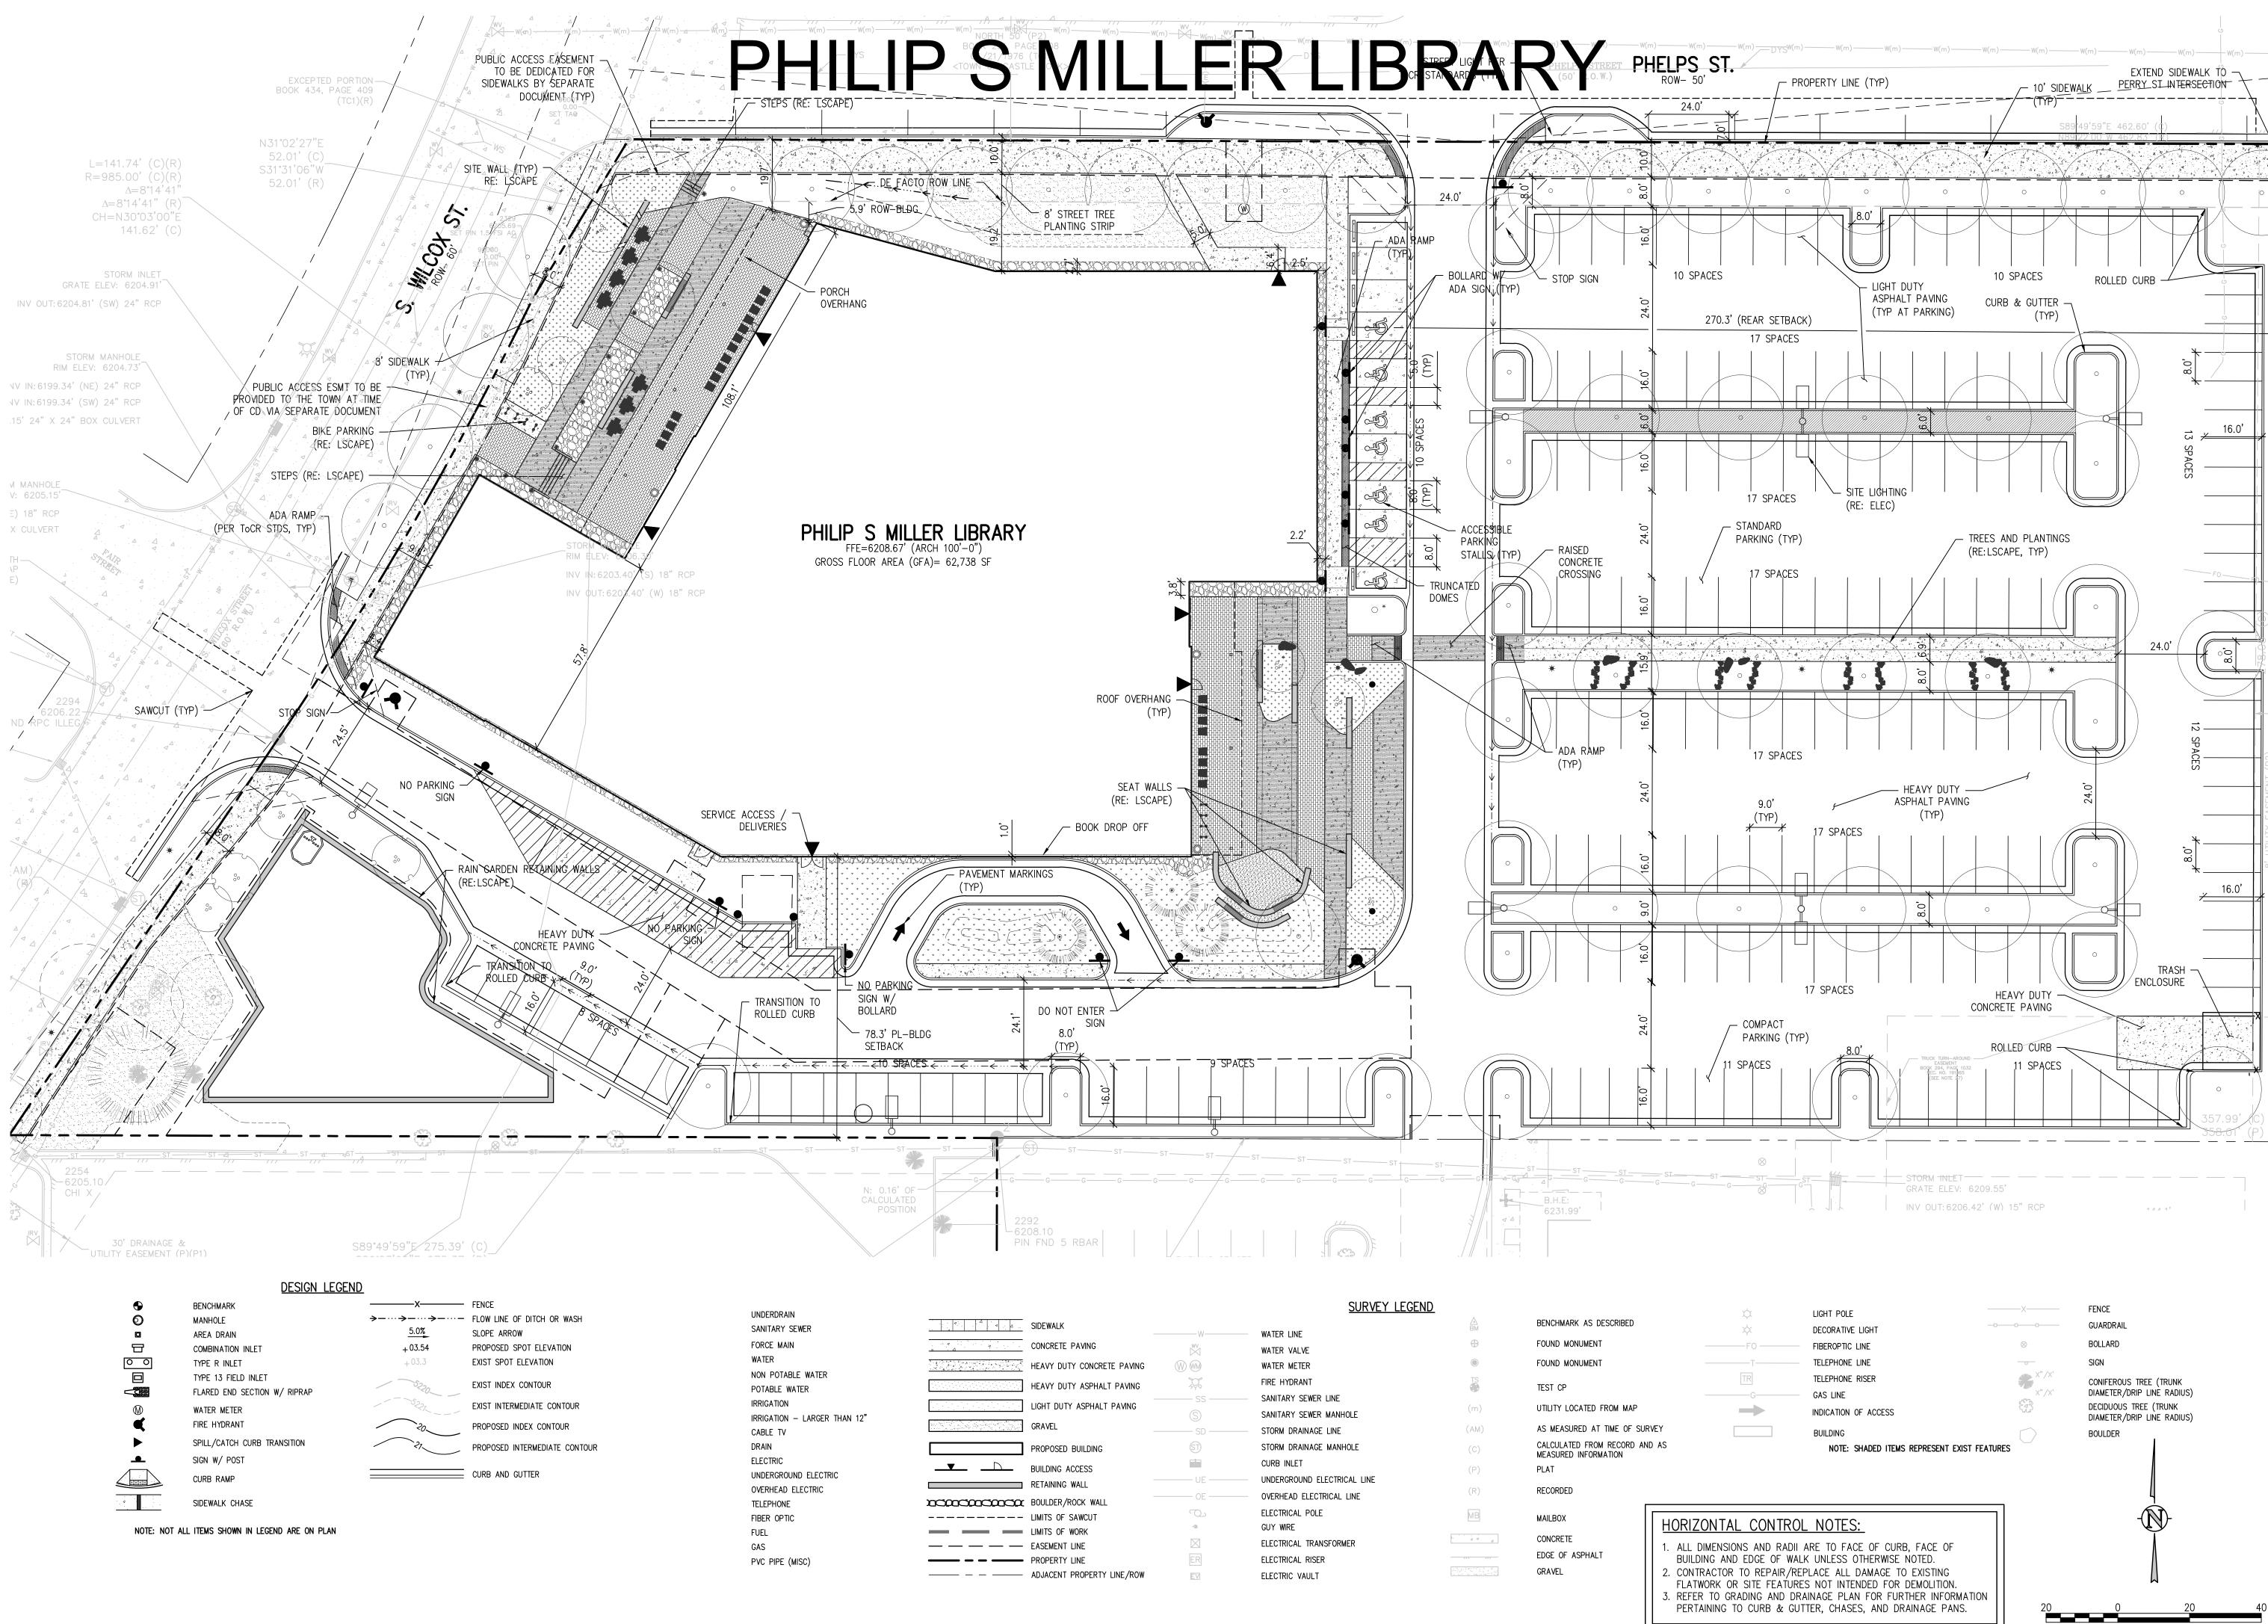
Sheet Number

SDP SUBMISSION 5 Sheet Name

5-SDP21-0042 TOWN OF CASTLE ROCK SDP GENERAL NOTES

3 OF 17

1/12/2022



SIDEWALK
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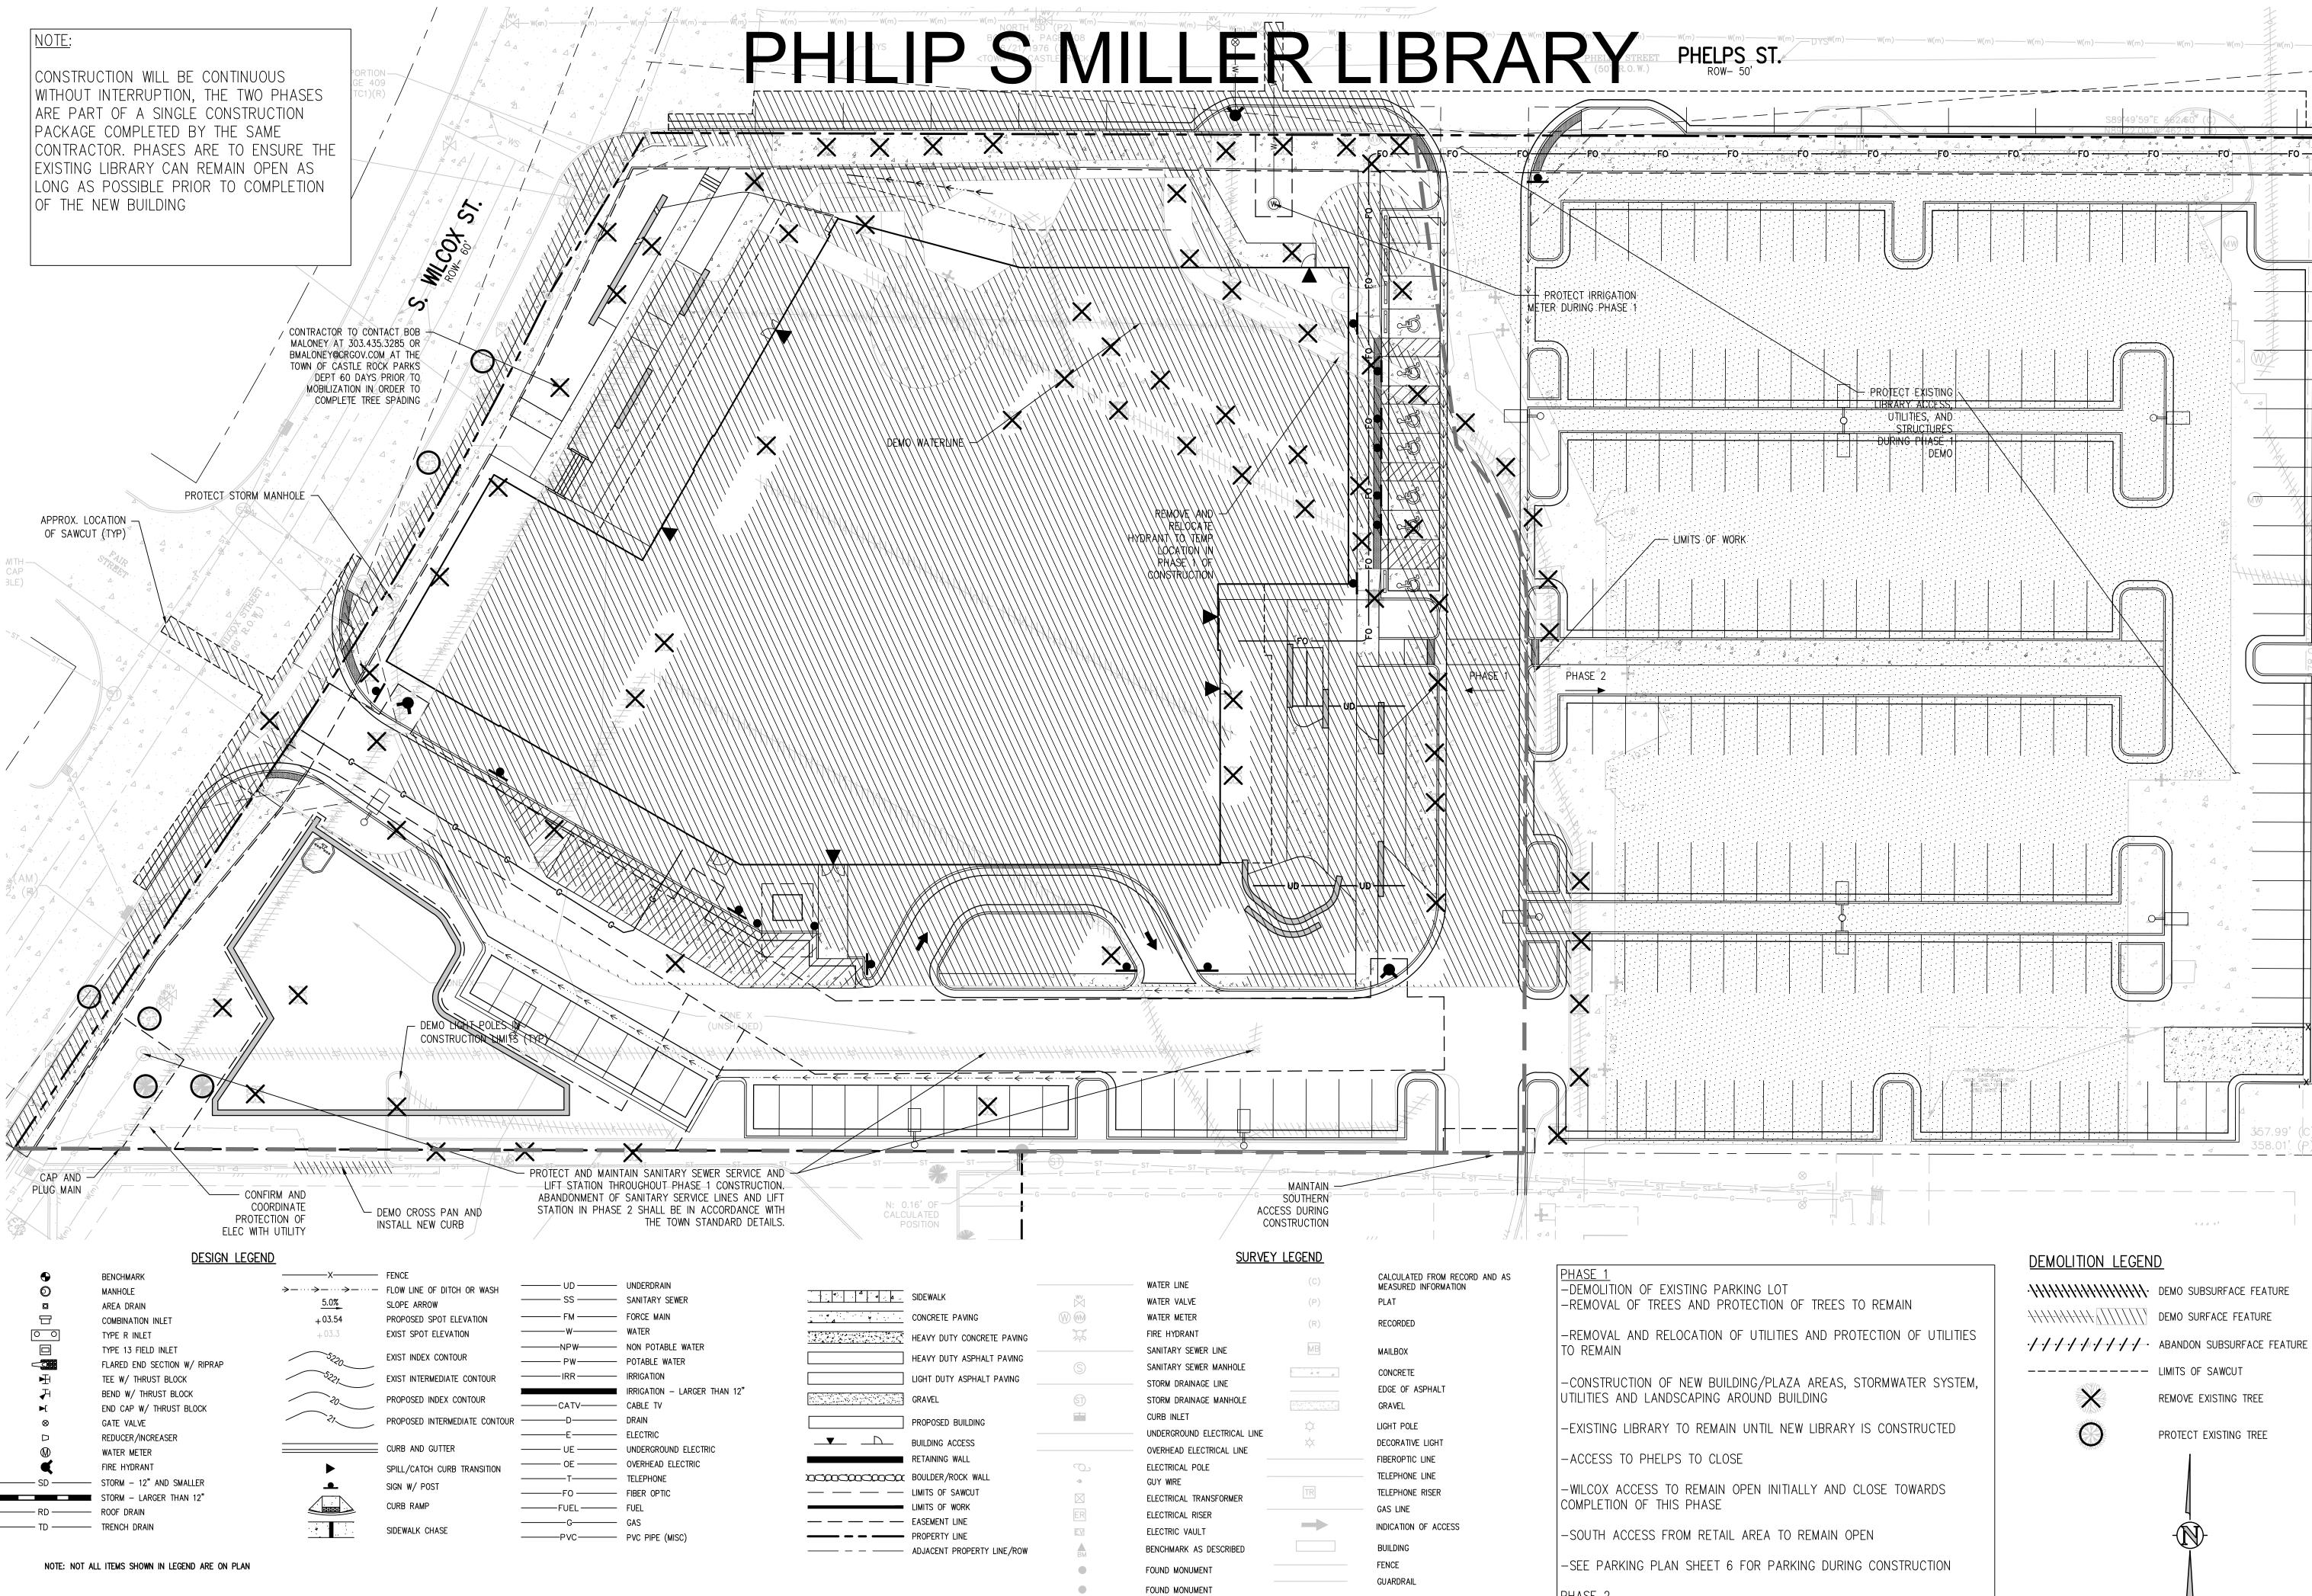
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5-SDP21-0042 SITE PLAN

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	······································						
UTILITY LOCATED FROM MAP							
AS MEASURED AT TIME OF SURVEY	ד / × دری						
	\square						

CALCULATED FROM RECORD MEASURED INFORMATION
PLAT
RECORDED
MAILBOX
CONCRETE
EDGE OF ASPHALT
GRAVEL
LIGHT POLE
DECORATIVE LIGHT
FIBEROPTIC LINE
TELEPHONE LINE
TELEPHONE RISER
GAS LINE
INDICATION OF ACCESS
BUILDING
FENCE
GUARDRAIL

BOLLARD SIGN CONIFEROUS TREE (TRUNK DIAMETER/DRIP LINE RADIUS) DECIDUOUS TREE (TRUNK DIAMETER/DRIP LINE RADIUS)

BOULDER

PHASE 2 ACCESS

NOTE: SHADED ITEMS REPRESENT EXIST FEATURES



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Douglas County Libraries 100 S. Wilcox St Castle Rock, CO 80104

Project Castle Rock Library

100 S. Wilcox St Castle Rock, CO 80104

General Contractor

Fransen Pittman 9563 South Kingston Court Englewood, CO 80112 P. 303-783-3900

Civil Engineer

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Landscape Architect

Back40 Landscape Architecture 2329 Cherry St. Denver, CO 80207 P. 720-236-6656

Structural Engineer

Jirsa Hedrick 8490 E. Crescent Pkwy Suite 250 Greenwood Village, CO 80111 P. 303-839-1963

Mechanical Engineer

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Electrical Enginee

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Low Voltage + Technology Consultant

Cevian 7535 E. Hampden Ave. #400 Denver, CO 80231 P. 720-723-0328

Seal	

evision	Description	

21212000 Sheet Issue Date SDP SUBMISSION 5 1/12/2022 Sheet Name

5-SDP21-0042 PHASING PLAN

Sheet Number

OPN Project No.


5 OF 17

SCALE IN F

-DEMOLITION OF EXISTING LIBRARY AND SURROUNDING CONCRETE WALKS,

-CONSTRUCTION OF NEW PARKING LOT, WALKS, RELATED LANDSCAPING, AND STORM SYSTEM CONNECTIONS AS WELL AS TRASH ENCLOSURE

-NEW CONNECTION TO PHELPS ST COMPLETED AND OPENED

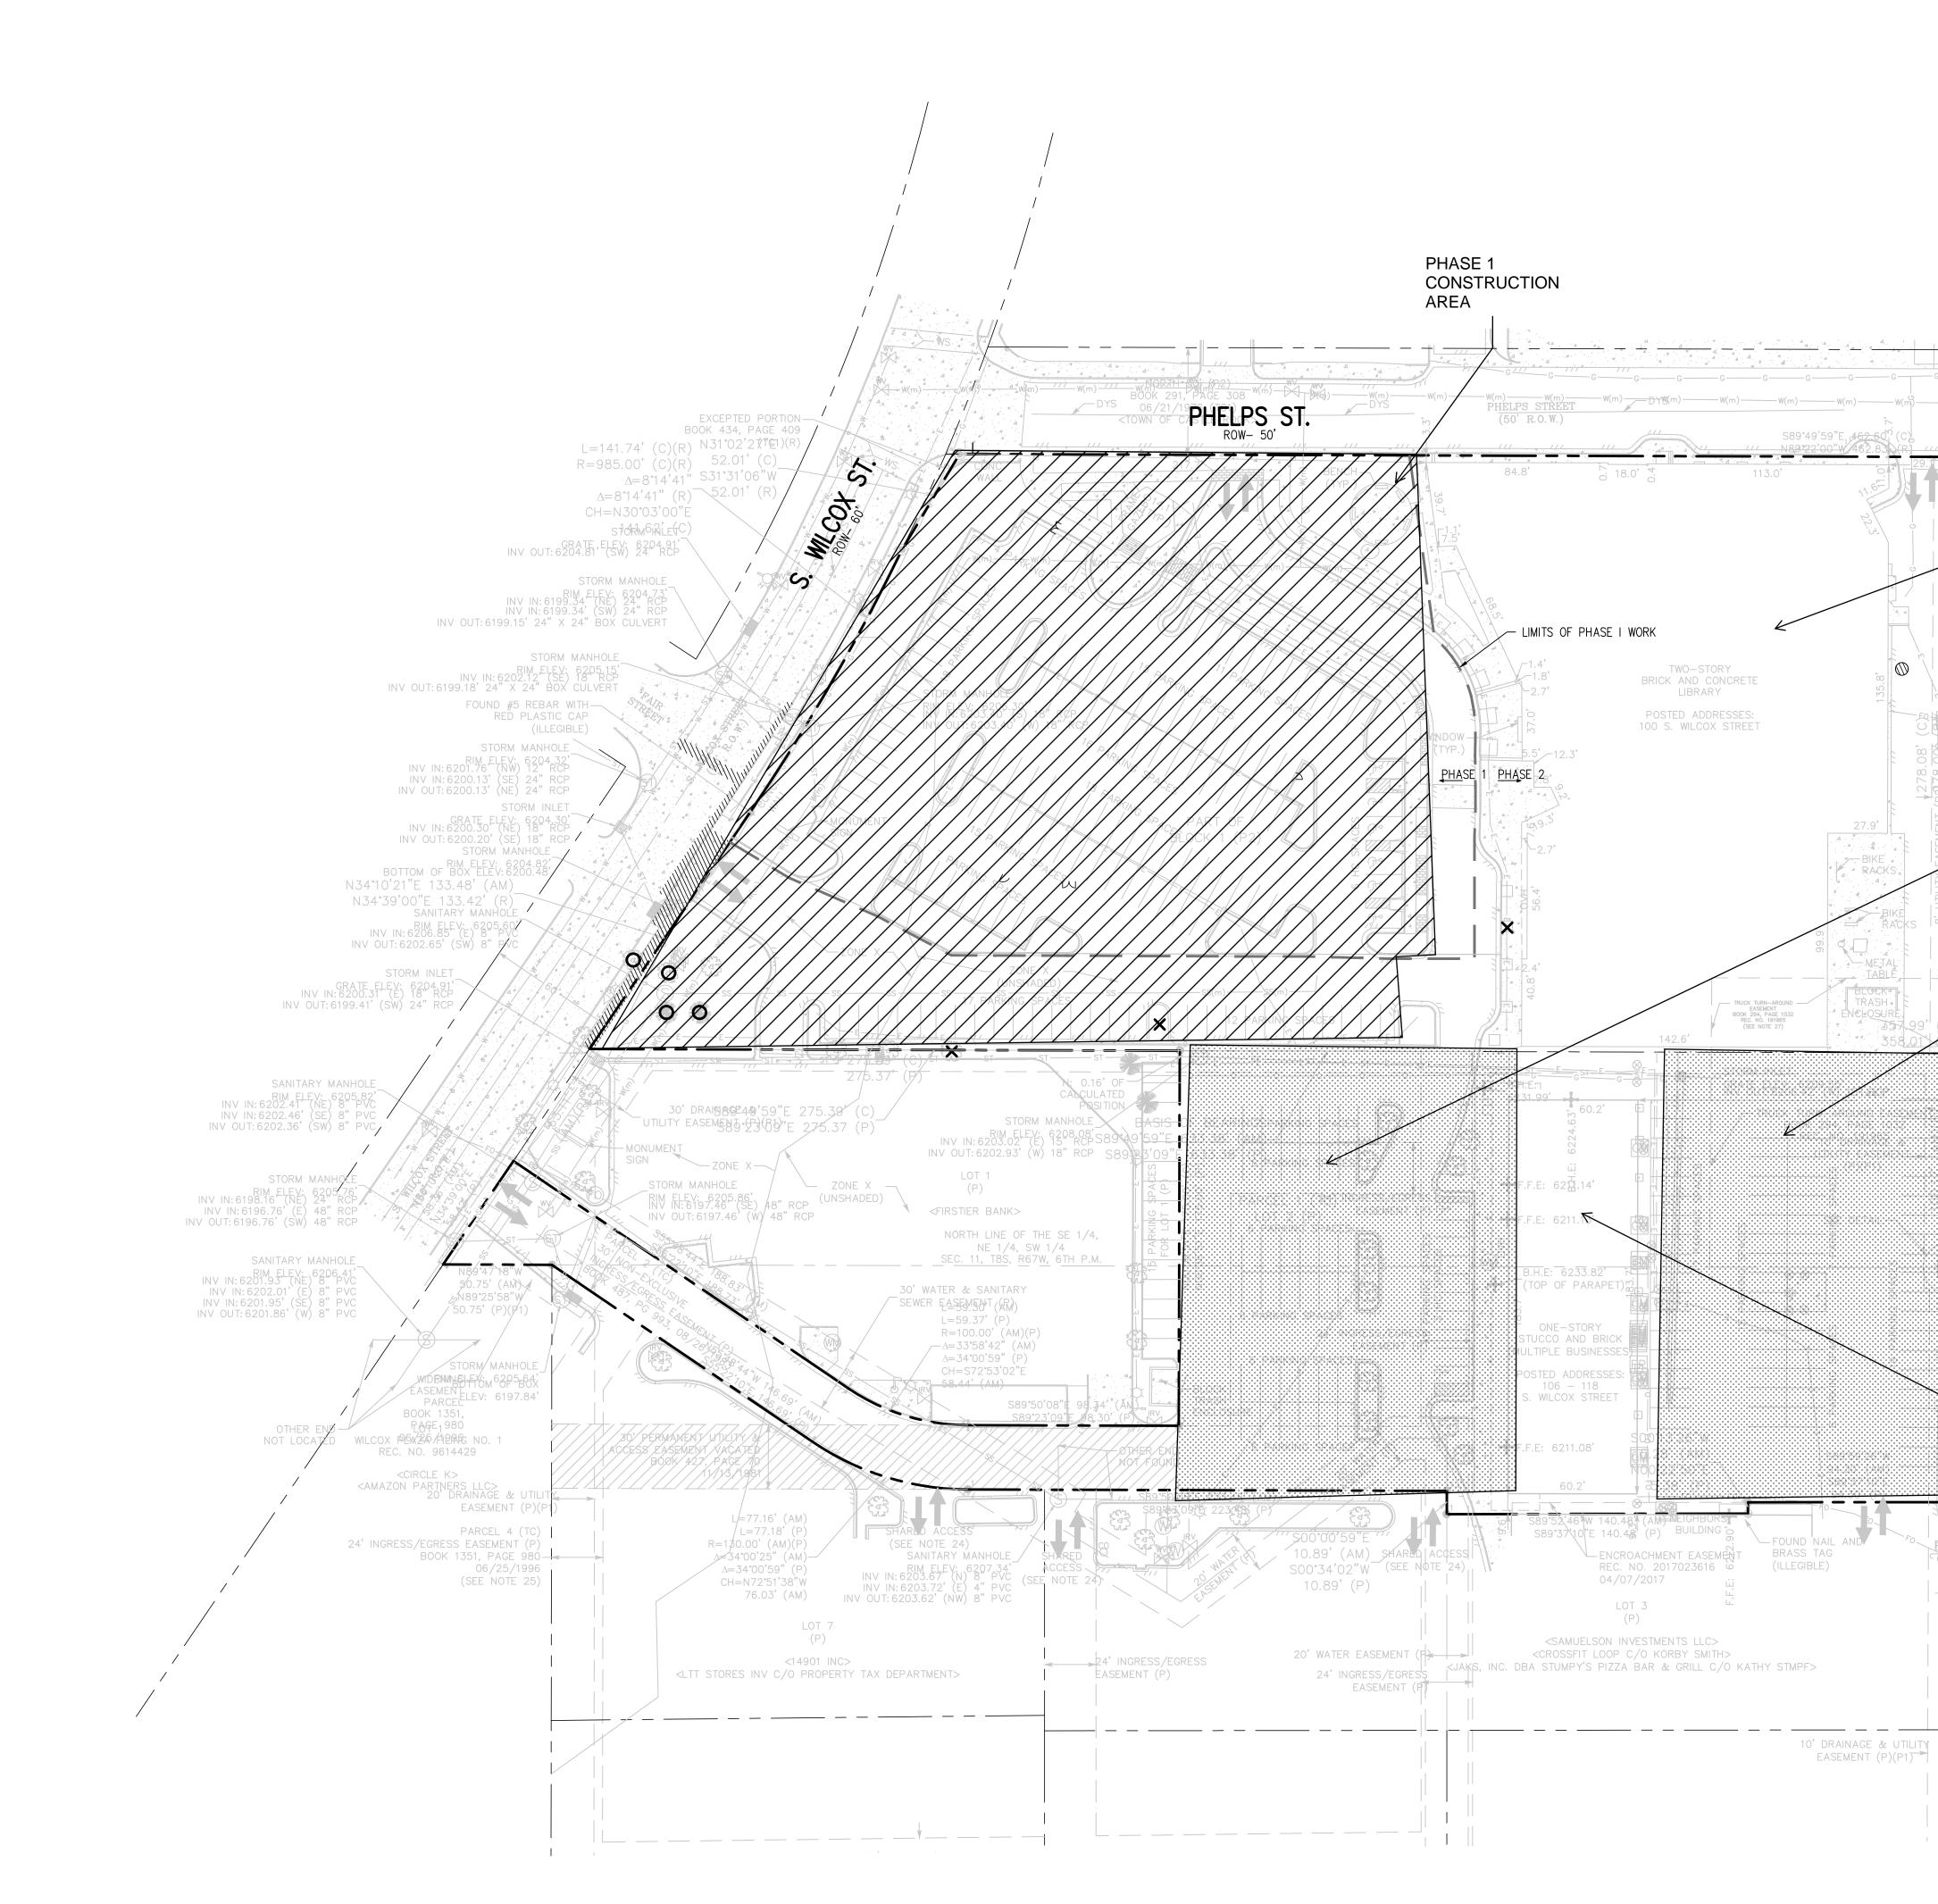

PHILIP S MILLER LIBRARY





4-SDP21-0042 PARKING PLAN

Sheet Issue Date SDP SUBMISSION 5 Sheet Name

1/12/2022

OPN Project No. 21212000

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Low Voltage + Technology Consultant Cevian

Centennial, CO 80111 P. 303-936-1633

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Jirsa Hedrick

Denver, CO 80207 P. 720-236-6656 Structural Engineer

Back40 Landscape Architecture

Boulder, CO 80302

Landscape Architect

2329 Cherry St.

P. 303-444-1951

9563 South Kingston Court

Englewood, CO 80112

P. 303-783-3900

1319 Spruce Street

Civil Engineer

JVA, Inc.

EXISTING 45,000 S.F. LIBRARY

CONSTRUCTION OF THIS AREA

REMAINS OPEN IN PHASE 1,

PARKING AREA

CONSTRUCTION

PARKING AREA

CONSTRUCTION

NEED 2/1000 SF FOR PARKING =

HAVE 109 SPACES ON LOT2 (FRONT

AND REAR) FOR FULL DURATION OF

SCALE IN FEE

90 PARKING SPACES

CONSTRUCTION

ALL RETAIL TENANTS WILL

CONSTRUCTION SO THIS AREA

CAN BE USED FOR PARKING

ACCESS AND CONSTRUCTION

VACATE PRIOR TO

PURPOSES

DURING

64 spaces

DURING

45 spaces

S88°44'57"E

2.60'(C)

2.60'(P)

S89°24'48"E

- FOUND BRÁSS TAG

AND NAIL (ILLEGIBLE)

2.60'(P1)

ONSITE BENCHMARK -FOUND #5 REBAR

ELEV: 6213.58'

DEMO AND PARKING

HAPPENS IN PHASE 2

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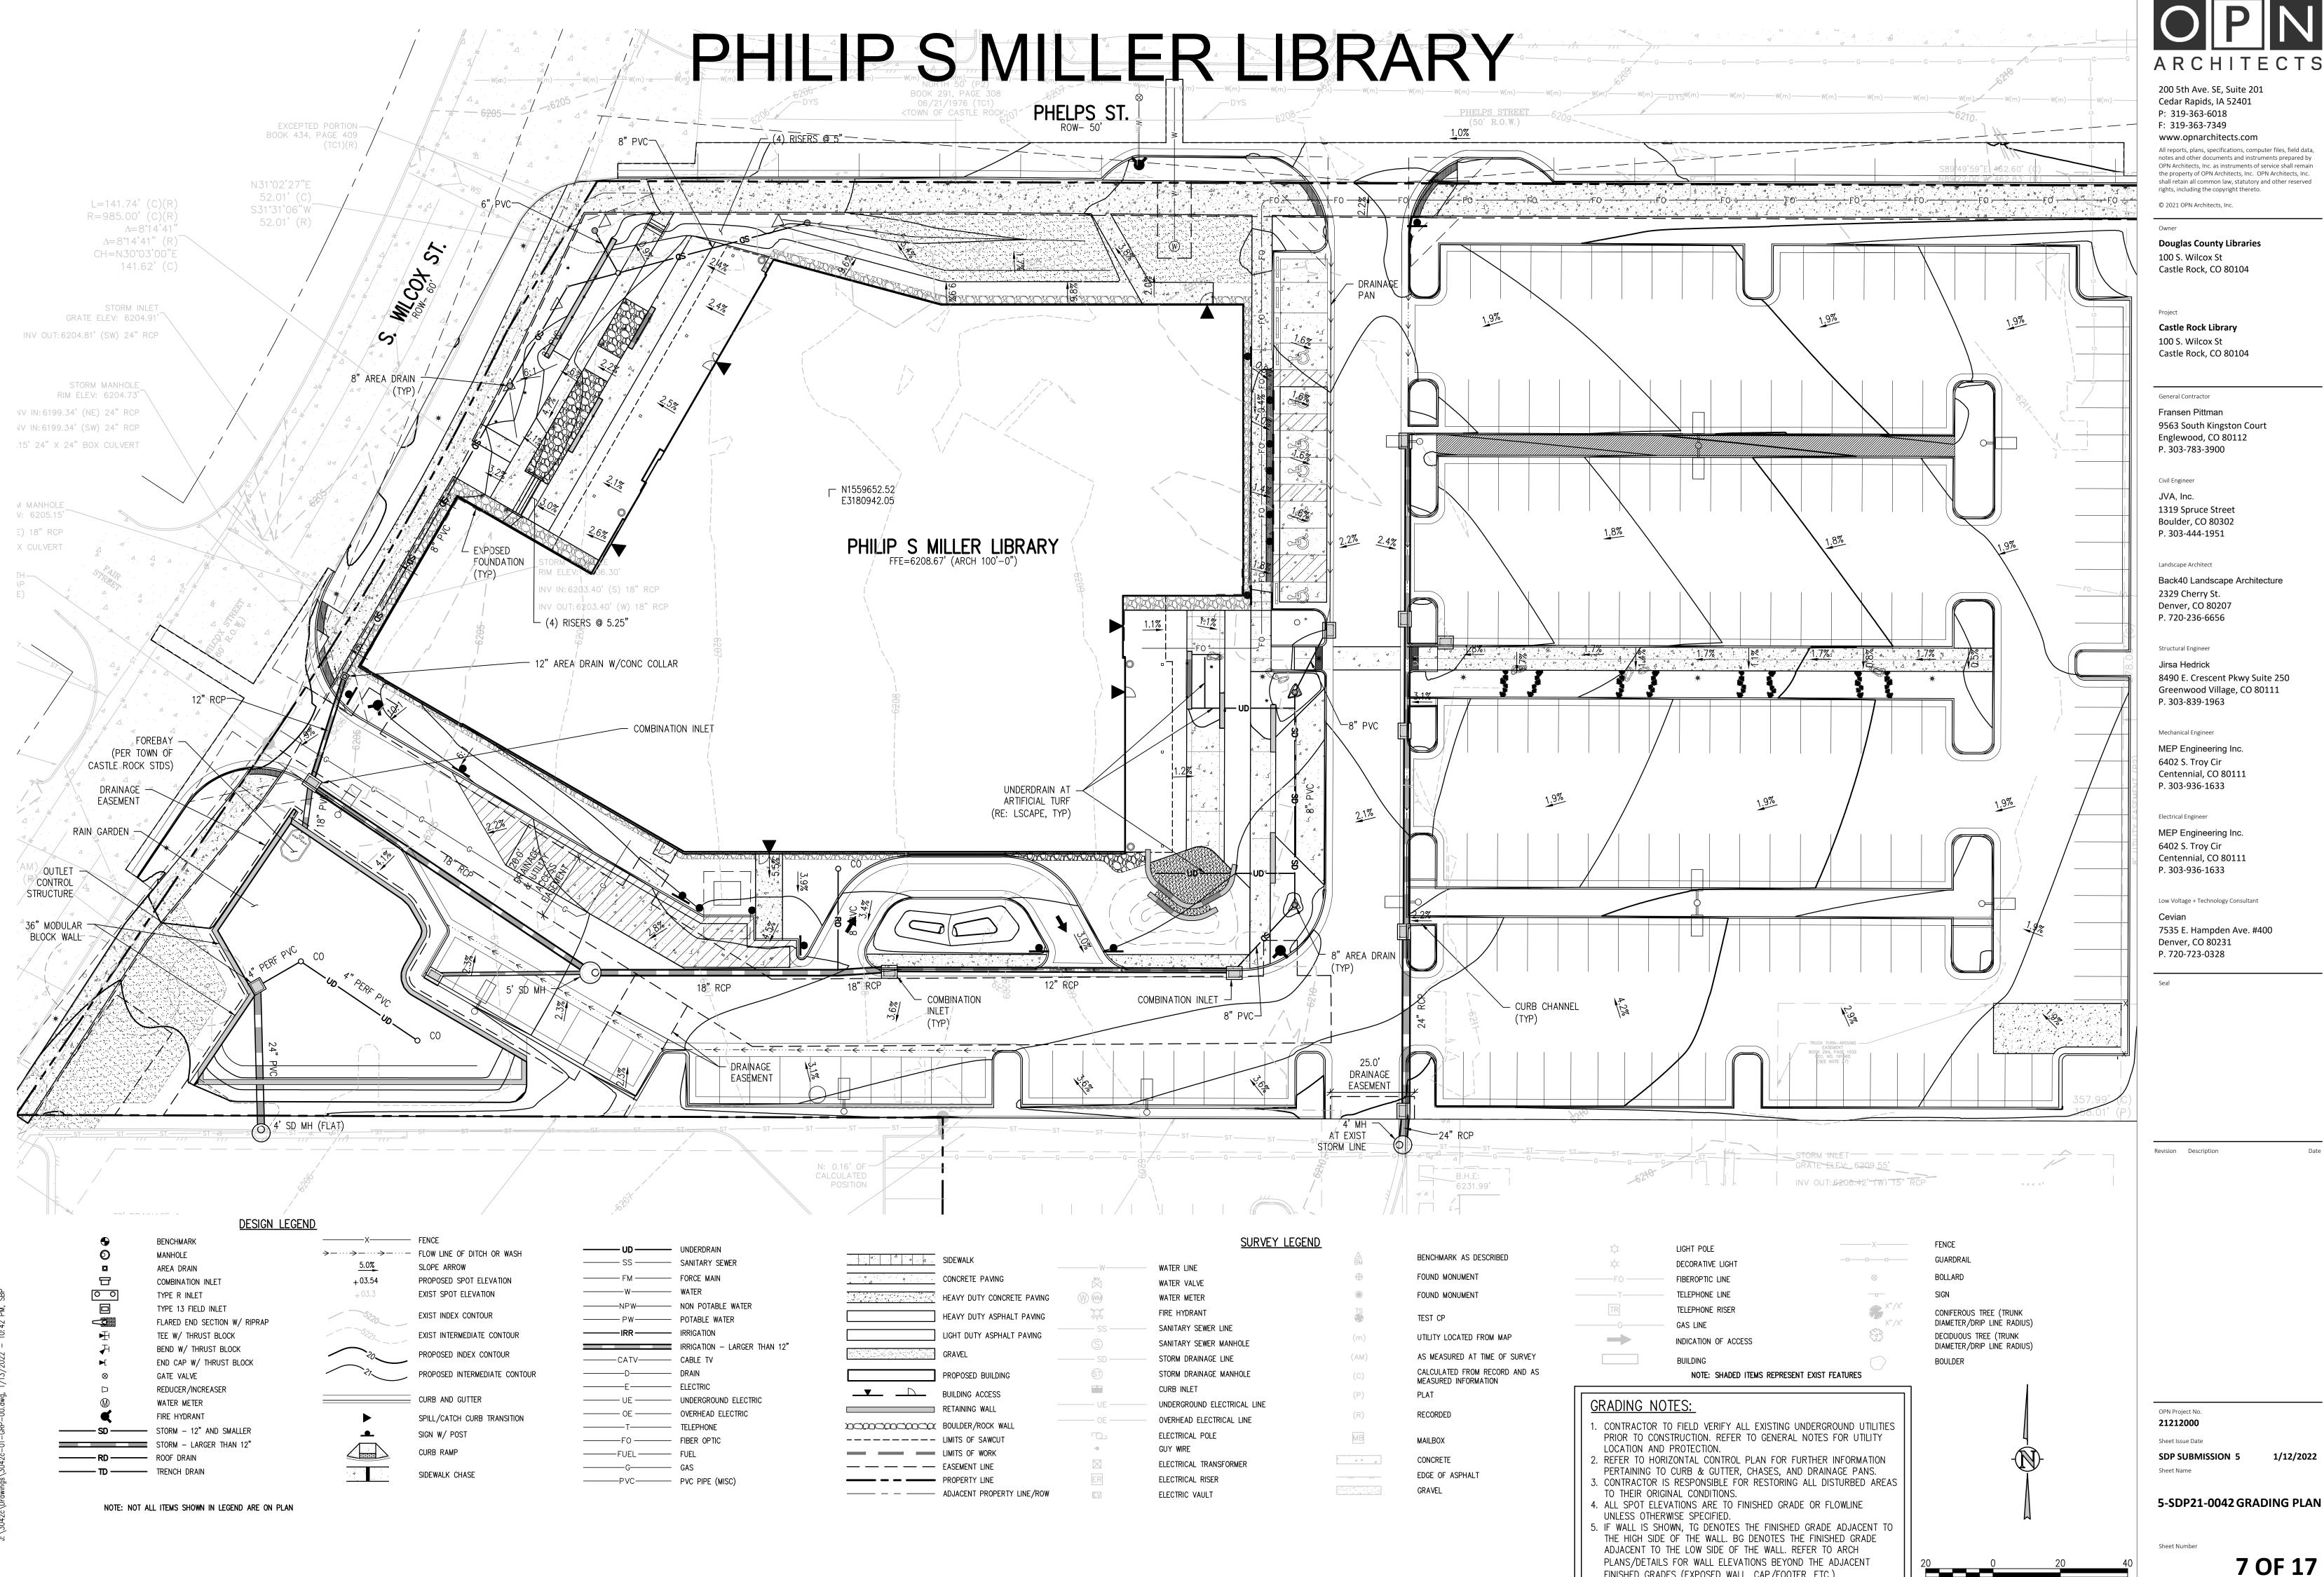
Castle Rock Library

100 S. Wilcox St Castle Rock, CO 80104

General Contractor Fransen Pittman

Owner

Project





 i.	

7 OF 17

SCALE IN FEET

FINISHED GRADES (EXPOSED WALL, CAP/FOOTER, ETC.)

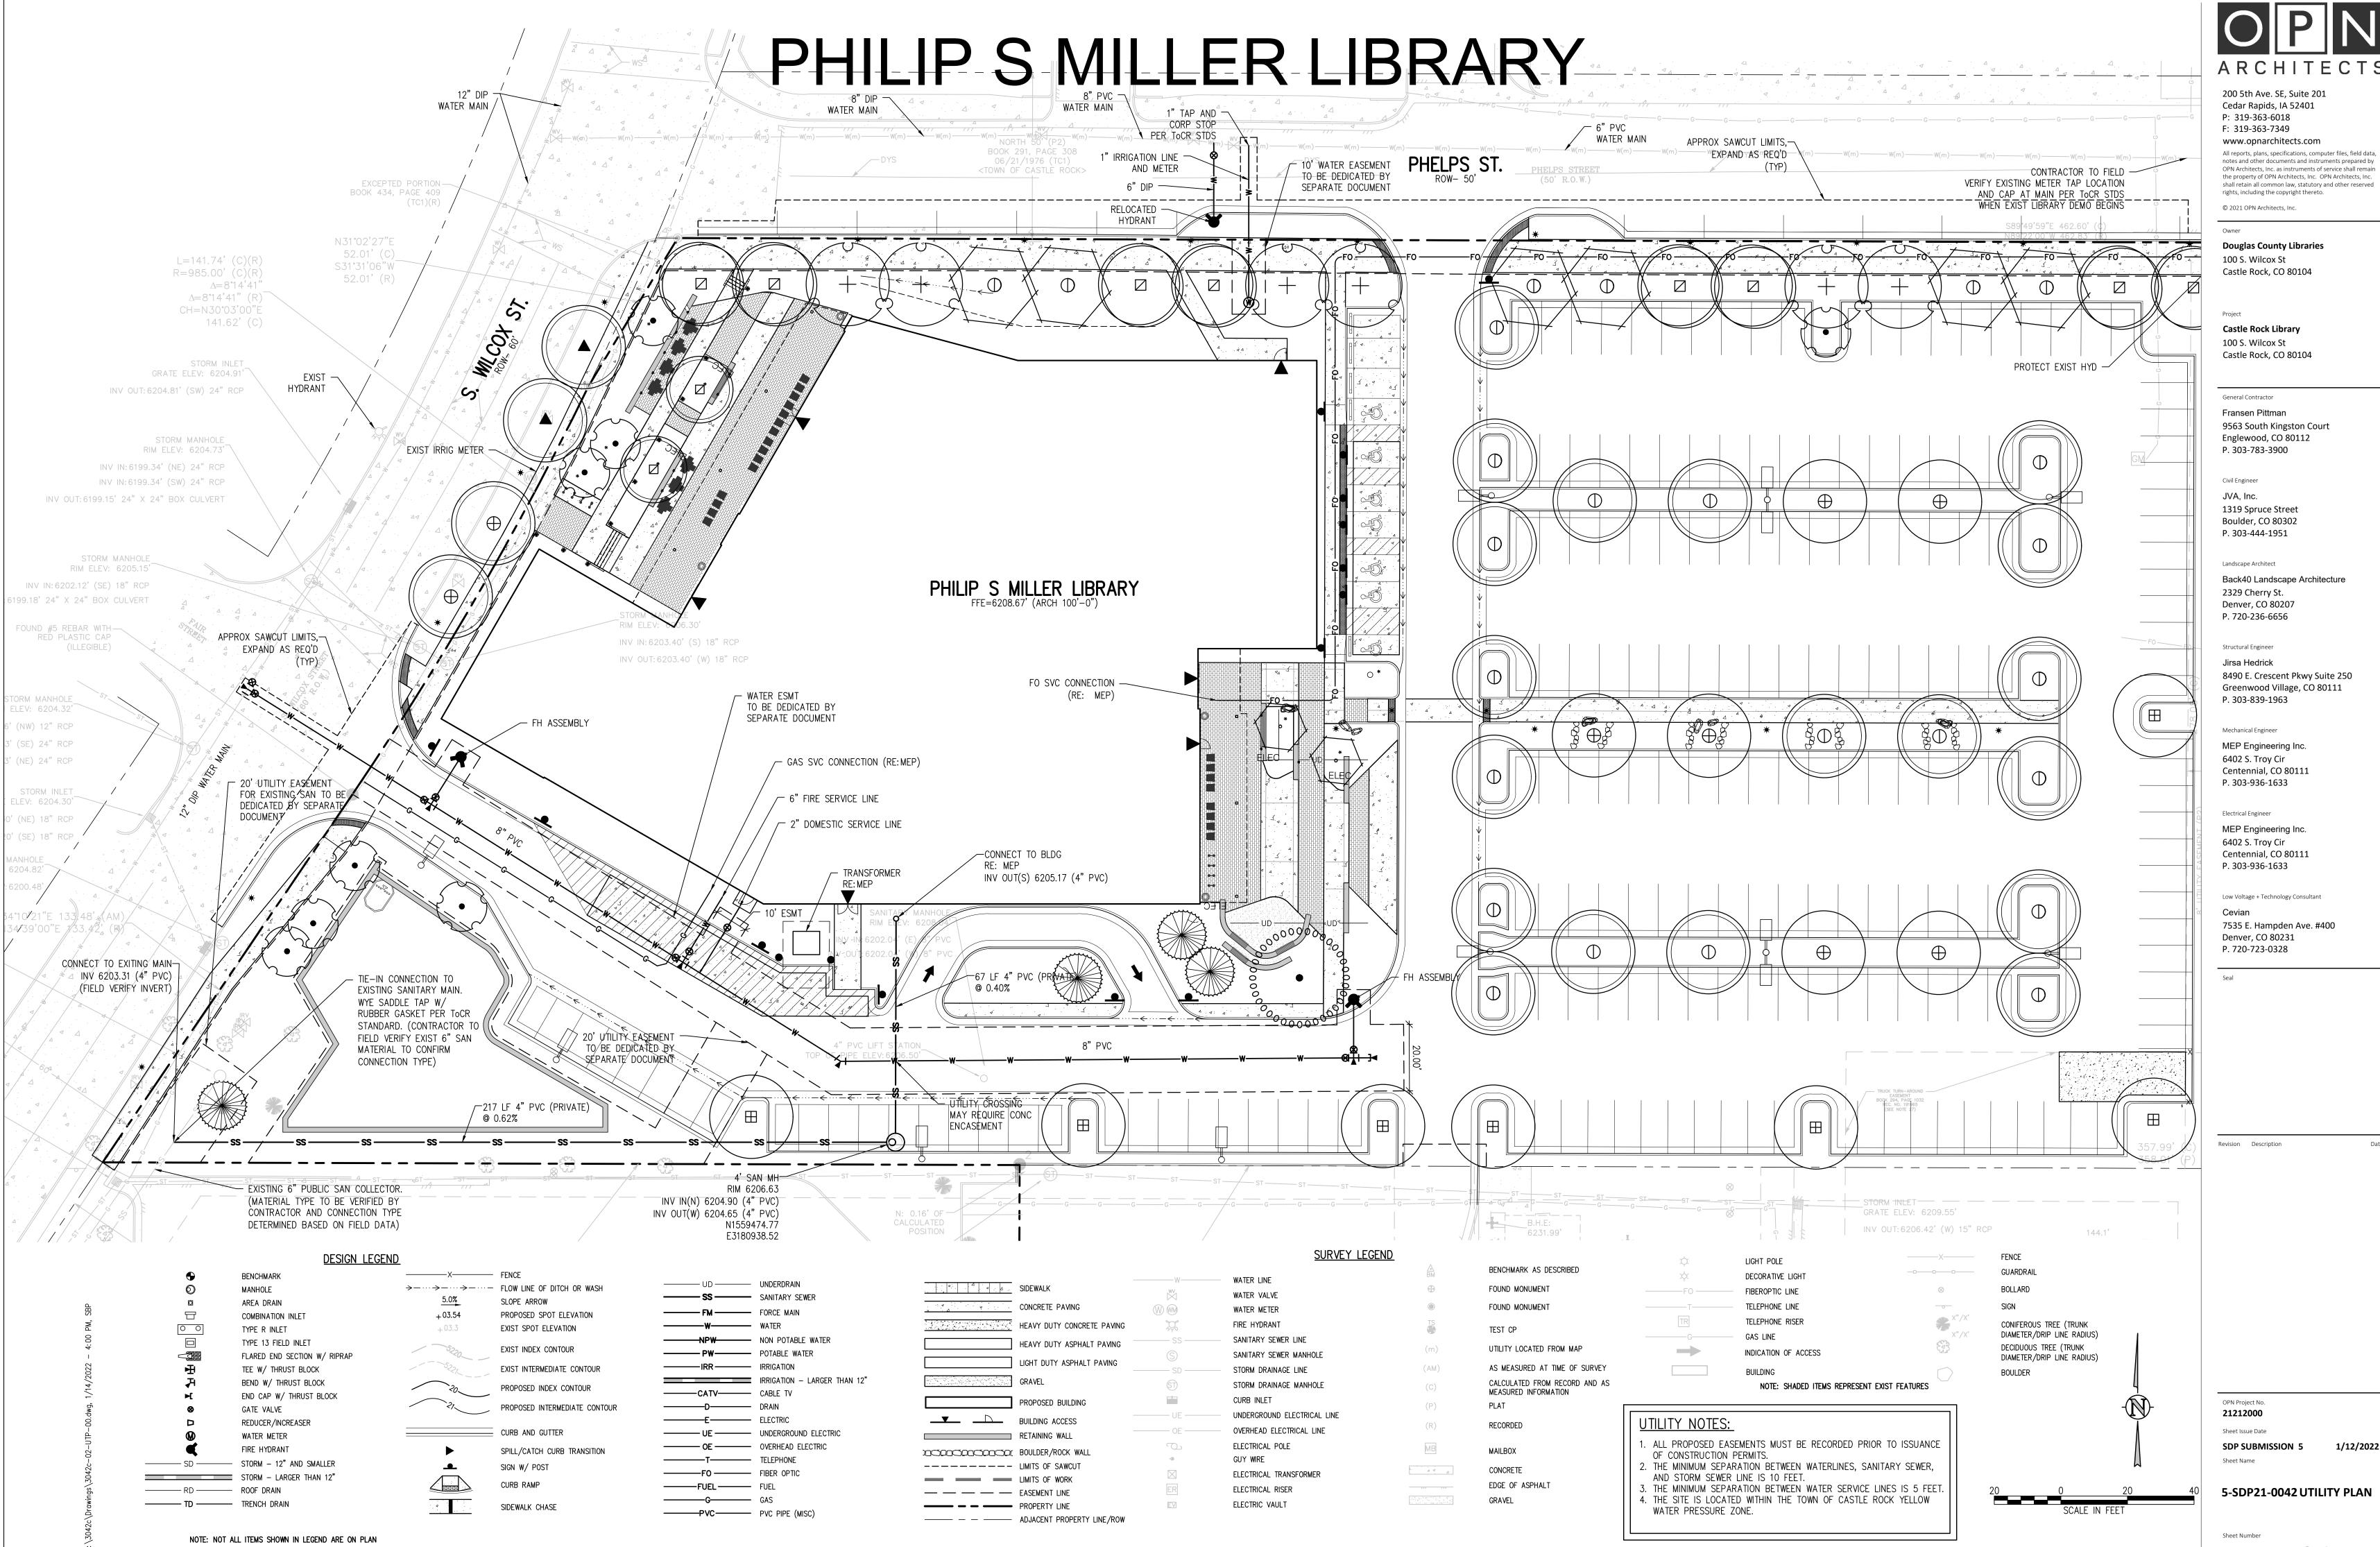

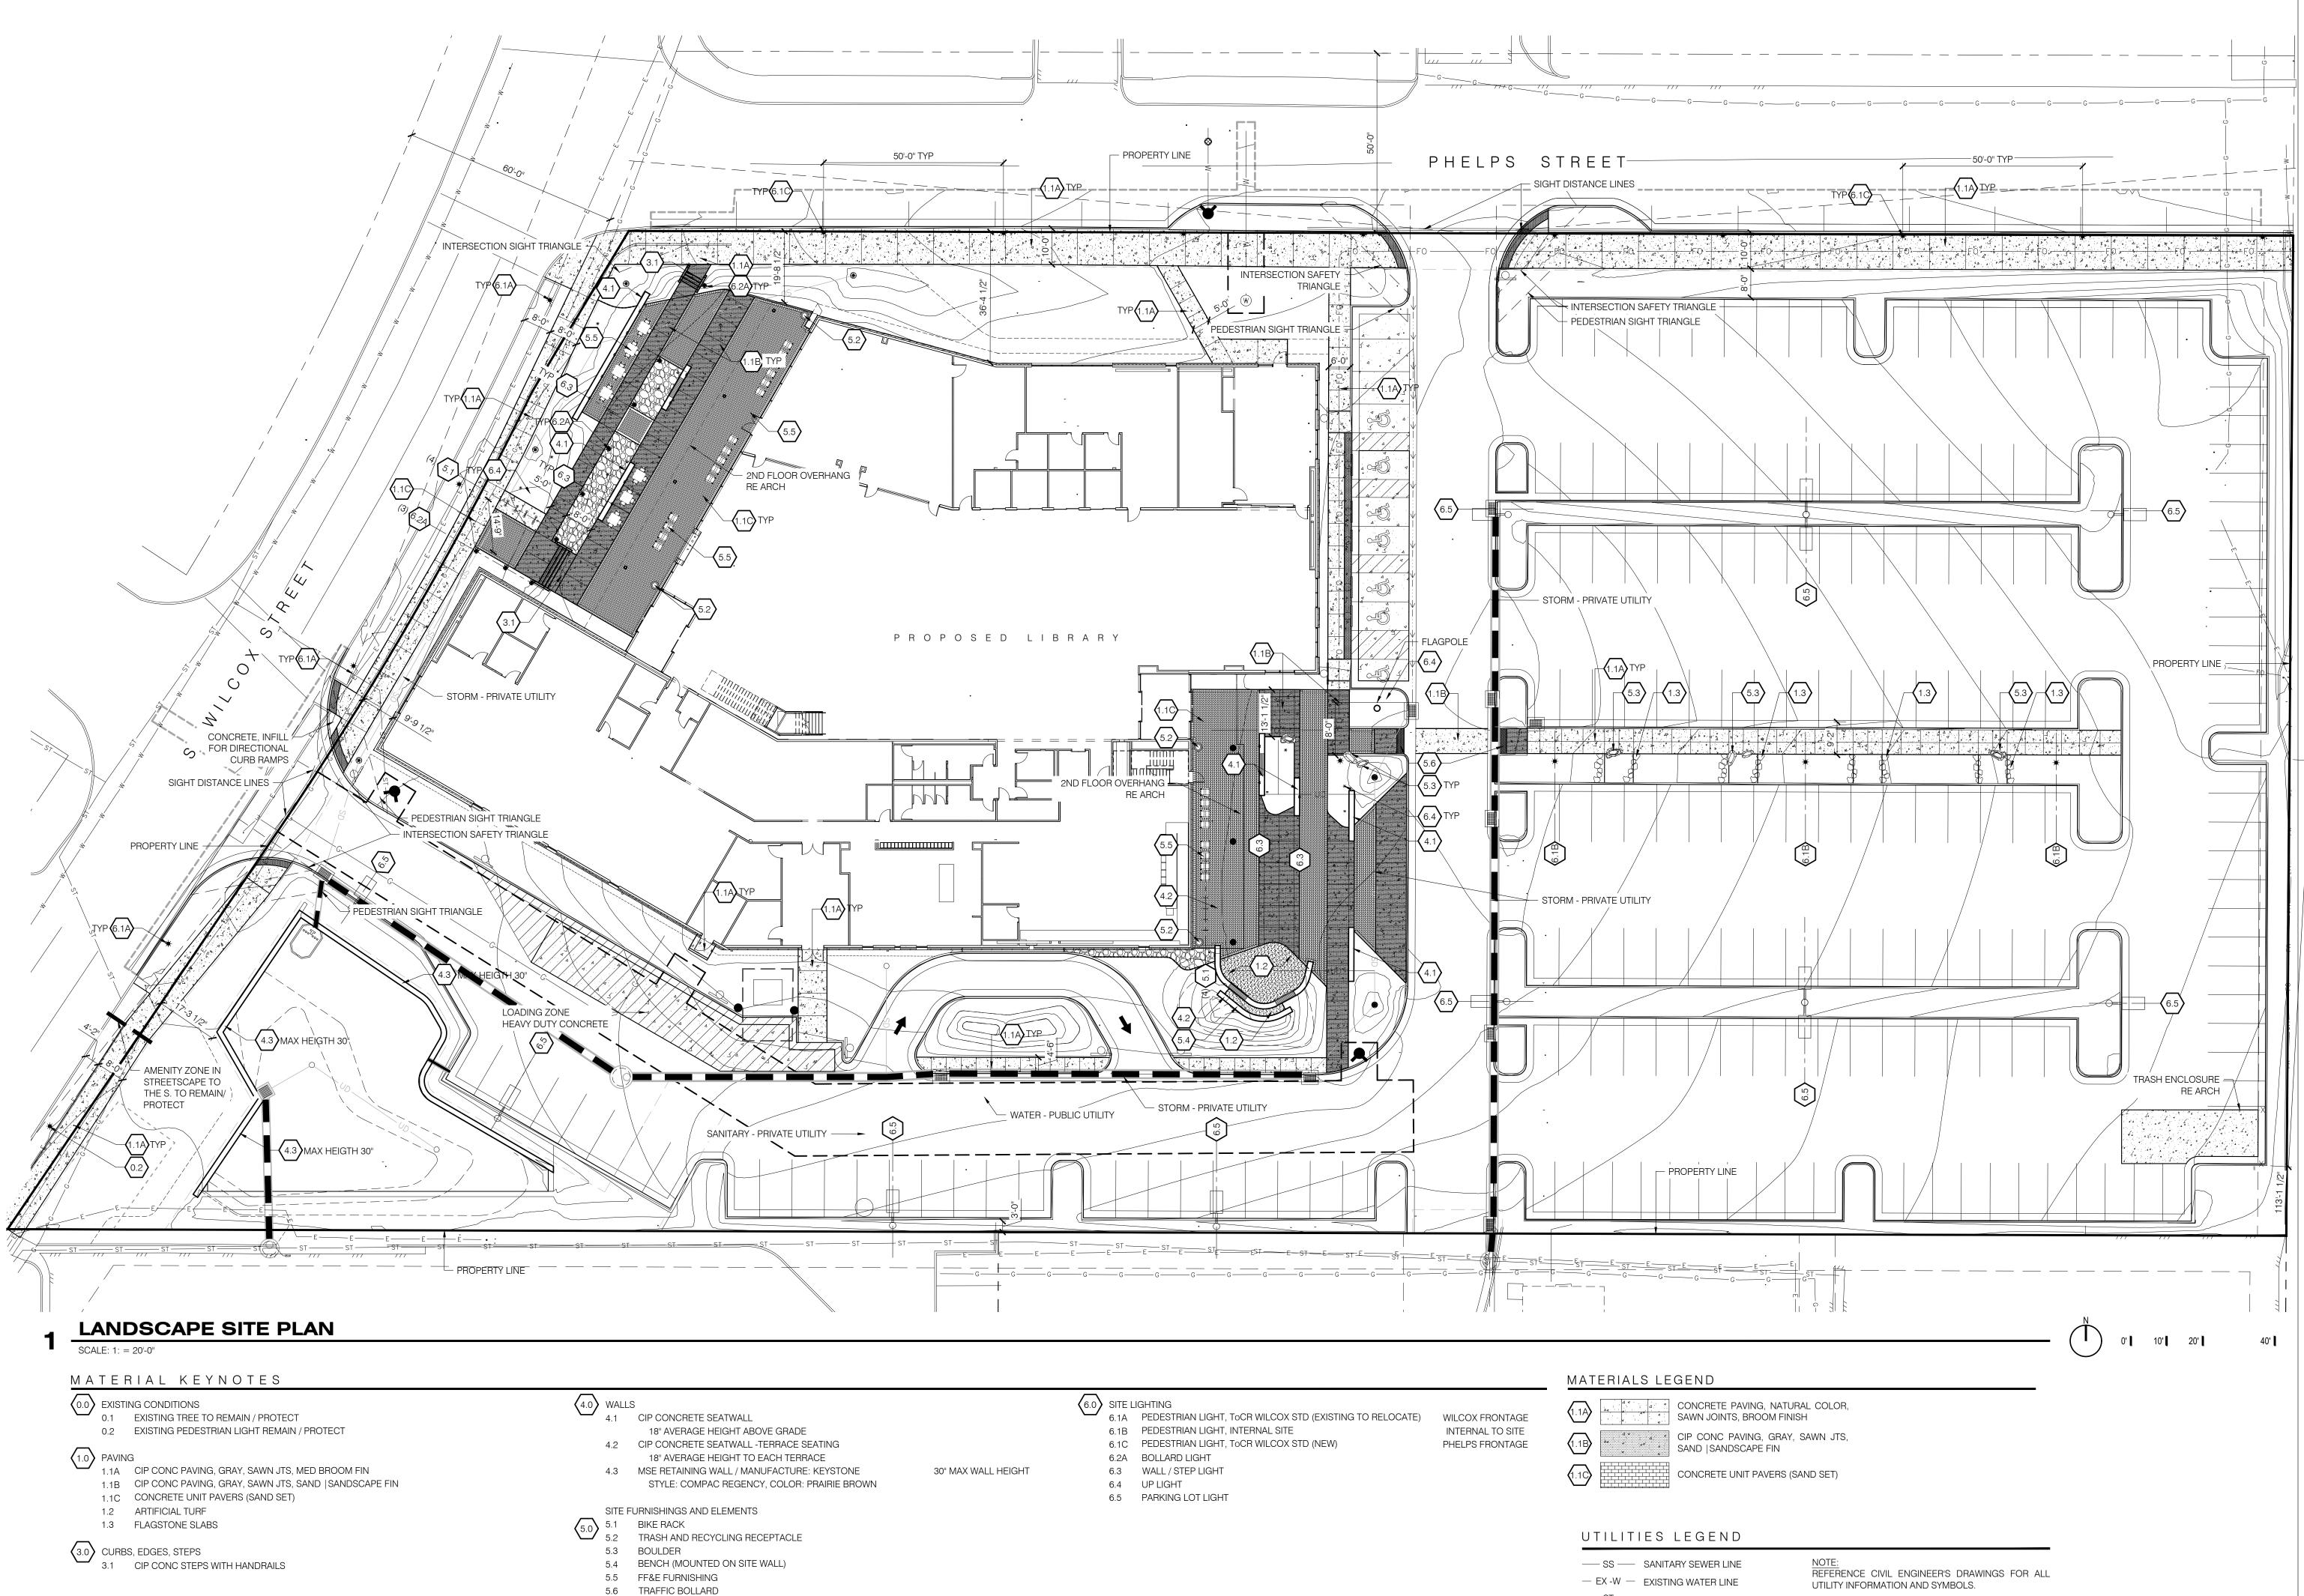

—— SS ——	SANITARY SEWER L
— EX -W —	EXISTING WATER LI
ST	STORM SEWER LINE
—— UE ——	UNDERGROUND EL
—— G ——	GAS LINE



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Low Voltage + Technology Consultant

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Revision Description

LECTRICAL LINE

Sheet Name 1-SDP21-0042

SDP SUBMISSION 5

LANDSCAPE PLAN -HARDSCAPE

Sheet Number


OPN Project No.

21212000

Sheet Issue Date

9 OF 17

1/12/2022

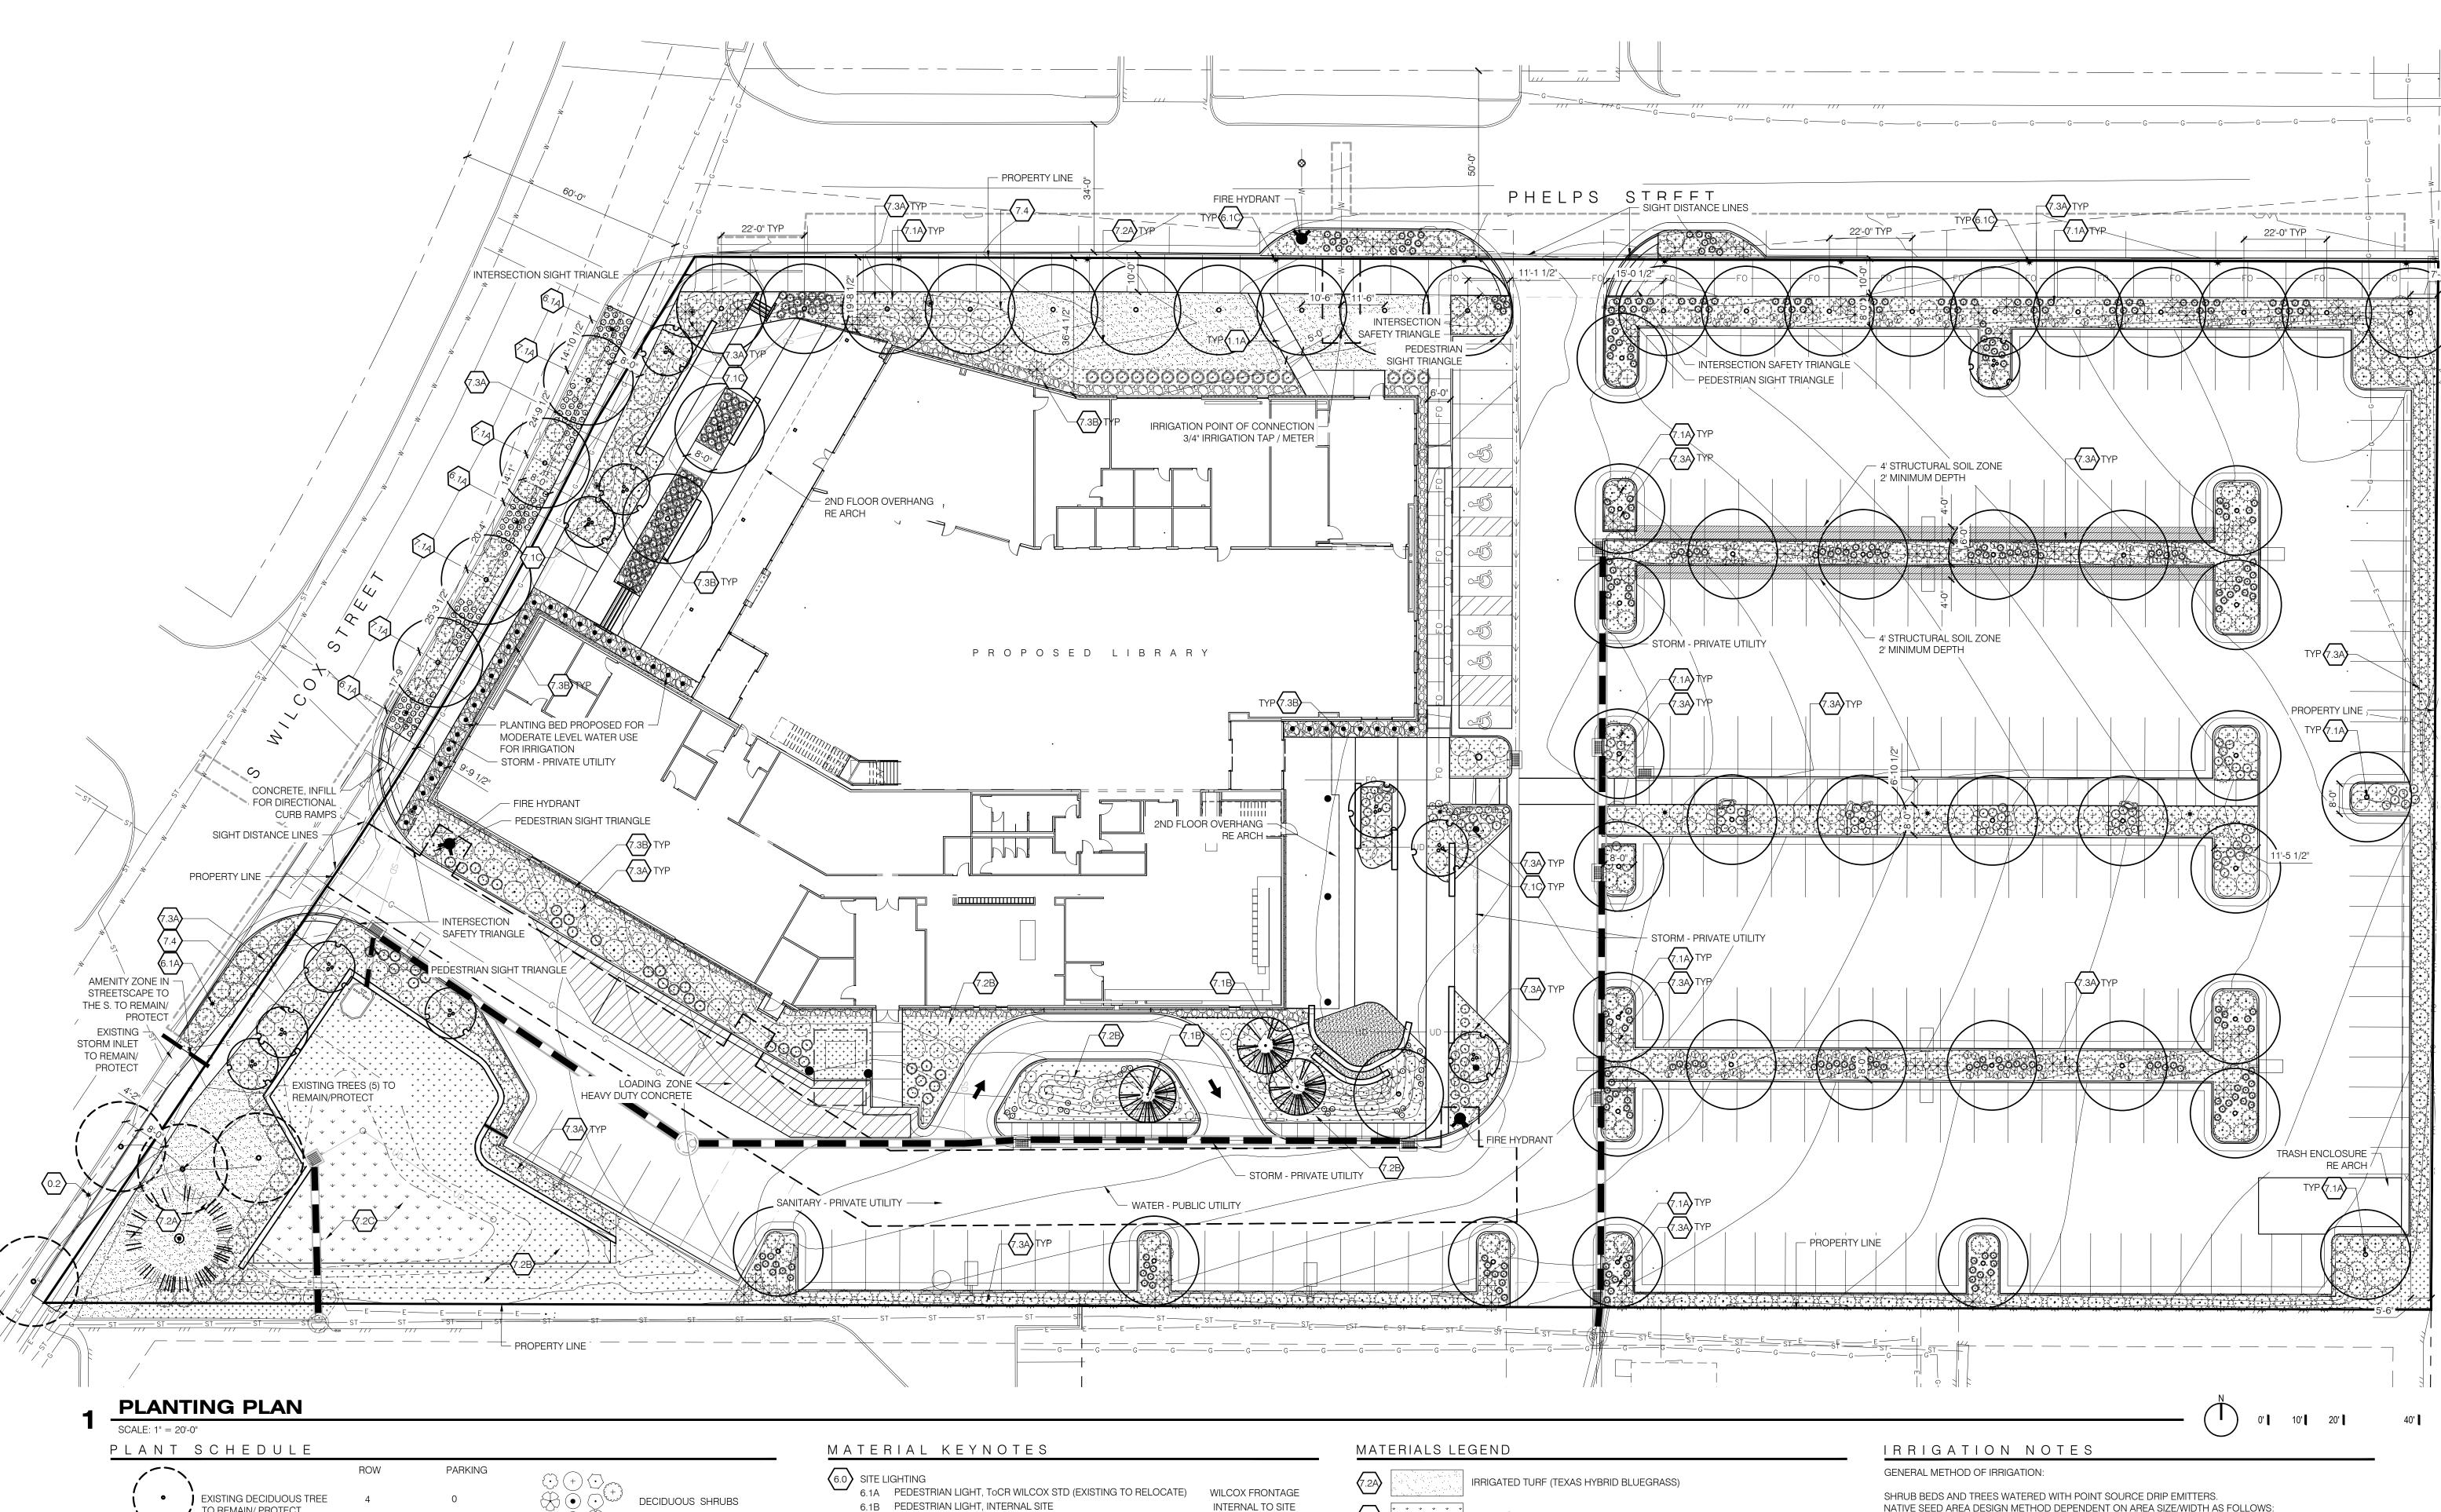

	000000000000000000000000000000000000						
P	'LANT	SCHEDULE					MATERIA
_		EXISTING DECIDUOUS TREE TO REMAIN/ PROTECT	ROW 4	PARKING 0	$\begin{array}{c} \begin{array}{c} \begin{array}{c} \begin{array}{c} \end{array} \\ \end{array} \\ \end{array} \\ \end{array} \\ \begin{array}{c} \end{array} \\ \end{array} \\ \begin{array}{c} \end{array} \\ \end{array} \\ \begin{array}{c} \end{array} \\ \end{array} \\ \end{array} \\ \begin{array}{c} \end{array} \\ \end{array} $	DECIDUOUS SHRUBS	6.0 SITE LIGHTIN 6.1A PEDI 6.1B PEDI 6.1C PEDI
		EXISTING EVERGREEN TREE TO REMAIN/ PROTECT	1	0		EVERGREEN SHRUBS	6.2A BOLI 6.3 WAL 6.4 UP L 6.5 PARI
		7.1A DECIDUOUS TREE	26	33		GRASSES	7.0PLANTING7.1ADEC7.1BEVEF7.1CORN
		7.1B EVERGREEN TREE	0	3	⊙ ⊕ Ø⊙	PERENNIALS	7.2A IRRIC 7.2B NATI 7.2C NATI
	(a)	7.1C ORNAMENTAL TREE	6	5			7.3A MUL 7.3B MUL 7.4 STEE
		TOTAL TREE % OF LARGE DECIDUOUS	37 81%	41 80%			

EDESTRIAN LIGHT, INTERNAL SITE EDESTRIAN LIGHT, ToCR WILCOX STD (NEW) PHELPS FRONTAGE OLLARD LIGHT

- ALL / STEP LIGHT P LIGHT ARKING LOT LIGHT
- ECIDUOUS TREE VERGREEN TREE
- RNAMENTAL TREE RIGATED TURF (TEXAS HYBRID BLUEGRASS)
- ATIVE SEED, TYPE 1
- ATIVE SEED, TYPE 2
- ULCH, SHREDDED WOOD (PLANTING AREA)
- ULCH, 2"-3" COBBLE (PLANTING AREA)
- TEEL EDGER

----- G ----- GAS LINE

(7.2B)

(7.2C)

(7.3A)

(7.3B)

NATIVE SEED, TYPE 1

NATIVE SEED, TYPE 2

MULCH, WOOD (PLANTING AREA)

MULCH, 2-3" COBBLE (PLANTING AREA)

- EX -W EXISTING WATER LINE

UTILITIES LEGEND

REFERENCE CIVIL ENGINEER'S DRAWINGS FOR ALL UTILITY INFORMATION AND SYMBOLS.

NATIVE SEED AREA DESIGN METHOD DEPENDENT ON AREA SIZE/WIDTH AS FOLLOWS: - <10' - INLINE SUBSURFACE DRIP; 10'-25' WIDTH - 12" POPUP SPRAY; > 25'- 12" ROTOR TURF AREA DESIGN METHOD DEPENDENT ON AREA SIZE/WIDTH AS FOLLOWS: - <10' - INLINE SUBSURFACE DRIP; 10'-25' WIDTH - 6" POPUP SPRAY; > 25'- 6" ROTOR

IRRIGATION POINT OF CONNECTION: AS CALLED OUT ON DRAWING

ALL PLANTING AREAS ASSUME LOW WATER USE WITH THE EXCEPTION OF TURFGRASS AREAS AND THEPLANTING BED NOTED ON THE PLAN LOCATED AT THE WESTERN BUILDING FRONTAGE



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Revision Description

OPN Project No. 21212000 Sheet Issue Date SDP SUBMISSION 5 Sheet Name

1/12/2022

1-SDP21-0042 LANDSCAPE PLAN

Sheet Number

CASTLE ROCK	Commercial	Landscape Sit	e Inventory
-------------	------------	---------------	-------------

Town of Castle Rock Registered Professional WILLIAM T BOWEN

Town of Castle Rock Registration # N/A State of Colorado License Landscape Architect # LA.0001108 Company Name BACK40 LANDSCAPE ARCHITECTURE Address 2329 CHERRY STREET, DENVER, COLORADO 80207 Phone _720.236.6656 Email <u>BILL@BACK40LA.COM</u> Date<u>2021-10-20</u>

PROJECT NAME DOUGLAS COUNTY LIBRARY - PHILIP S. MILLER BRANCH

Gross Site Area	Landscape Area in Sq.Ft.	Turfgrass List Species (Area in Sq.Ft.)	Nonliving Ornamental (Area in Sq.Ft.)	No. of Trees Required	No. of Trees Provided	No. of Shrubs Required	No. of Shrubs Provided	Soil Prep Amounts (In cu.yds. per 1000 Sq.Ft.)	Separate Irrigation Service Connections
151,338 SF	N/A	N/A	N/A	N/A	N/A	N/A	N/A	N/A	Yes <u>X</u> No
Parking Lot (Area in Sq.Ft.)	Parking Lot Landscape Area (Sq. ft.)	No. of Parking Spaces	Nonliving Ornamental (Area in Sq.Ft.)	No. of Interior Landscape Islands	Minimum Width of Interior Landscaped Islands	No. of Trees Required	No. of Trees Provided	No. of Shrubs Required	No. of Shrubs Provided
69,379 SF	11,395 SF	206	N/A	14	6'-0" SEE NOTE 2 BELOW	14	33	28 OR (4 / 1000 SF)	308

1. VARIANCE FOR REQUIRED PARKING ISLANDS BETWEEN PARKING SPACES APPROVED VIA TCV21-0072

2. VARIANCE FOR MINIMUM REQUIRED WIDTH FOR PARKING LOT ISLAND APPROVED ADMINISTRATIVELY. SEE TCV21-0094

CLWUR CHART

CLWUR (Composite landscape water use rating) Chart

Project Name: Douglas: County Libraries - Castle Rock Library Site Development Plan (SDP) Number: 1-SDP21-0042

	STLE ROCK				SDP) Number: 1-SI		/	
Irrigation Spray or Drip?	Plant Name (Common)	Appl. Rate (inches/month)	Zone (VL,L,Mod,HW)	% of Total Area	IA Irrigated area (in sq. ft. for each zone)	LWUR Landscape Water Use Rating	TA Total Area of all Irrigated Landscape Zones	clwur (LWUR x IA) /TA
Spray	Texas Hybrid Bluegrass	3.8	High		5,216	3.8	34,558	0.57
Spray	Native Seed 1	1.4	Very low		4,917	1.4	34,558	0.20
Spray	Native Seed 2	1.4	Very low		1,569	1.4	34,558	0.06
Drip	Shrub Bed (Hydrozone 2)	2	Low		22,151	2	34,558	1.28
Drip	Shrub Bed (Hydrozone 3)	2	Low		705	2	34,558	0.04
						Tota	I of the CLWUR	2.16

Reference Chapter 13.20 of the Castle Rock Municipal Code

LANDSCAPE NOTES

- 1. FINAL LANDSCAPE AREA, COVERAGE AND PLANT QUANTITIES, SHALL MEET OR EXCEED QUANTITIES REPRESENTED IN THIS DRAWING AND SHALL CONFORM TO SUBSEQUENT SUBMITTAL REQUIREMENTS.
- 2. LOCATION OF PLANT MATERIALS ARE APPROXIMATED AND MAY CHANGE SLIGHTLY DUE TO UNFORESEEN FIELD CONSTRAINTS.
- 3. ALL PLANTS ARE TO BE PROPERLY HYDROZONED PER TOWN OF CASTLE ROCK PLANT LIST.
- 4. DISTANCE OF TREES TO WET UTILITY LINES SHOULD BE A MINIMUM OF 10 FEET.
- 5. PERMANENT IRRIGATION IS REQUIRED FOR ALL LANDSCAPED AREAS GREATER THAN 500 SQUARE FEET, PER SECTION 4.2.3 OF THE LANDSCAPE AND IRRIGATION MANUAL.
- 6. DESIGN MUST ACCOMMODATE THE WATERING RESTRICTIONS AS OUTLINED IN THE TOWN OF CASTLE ROCK WATER USE MANAGEMENT PLAN (WUMP).
- 7. IRRIGATION SYSTEMS ARE TO BE DESIGNED TO OPERATE WITHIN THE TOWN OF CASTLE ROCK WATER USE MANAGEMENT PLAN.
- 8. IRRIGATION SYSTEMS ARE TO BE DESIGNED PER THE TOWN OF CASTLE ROCK LANDSCAPE AND IRRIGATION REGULATIONS SECTION 4.2.3 AND TO CORRELATE WITH THE USE TYPE ON THE PROPERTY.
- 9. IF ANY TRANSFORMERS, GROUND-MOUNTED HVAC UNITS, UTILITY PEDESTALS, OR SIMILAR FEATURES EXISTING ON SITE, BUT NOT SHOWN ON THE SITE DEVELOPMENT PLAN, ADDITIONAL LANDSCAPING AND SCREENING MAY BE REQUIRED BASED UPON FIELD CONDITIONS DETERMINED DURING THE SITE INSPECTION. INSTALLATION WILL BE REQUIRED PRIOR TO THE FINAL INSPECTION AND THE ISSUANCE OF THE CERTIFICATE OF OCCUPANCY, AS APPLICABLE.
- 10. NO SOLID OBJECT EXCEEDING 30" IN HEIGHT ABOVE THE FLOWLINE ELEVATION OF THE ADJACENT STREET, INCLUDING, BUT NOT LIMITED TO BUILDING, UTILITY CABINETS, WALLS, FENCES, TREES, LANDSCAPE PLANTINGS, CUT SLOPES AND BERMS SHALL BE PLACED IN SIGHT DISTANCE TRIANGLES OR EASEMENTS AS SHOWN ON THE PLAN.
- 11. NO TREES, LARGE SHRUBS, OR PERMANENT STRUCTURES ARE ALLOWED IN WET UTILITY AND DRAINAGE EASEMENTS.
- 12. AN IRRIGATION PLAN IS REQUIRED WITH THE FIRST SUBMITTAL OF THE CONSTRUCTION DOCUMENTS. PLEASE SEE SECTIONS 3.1.2B AND 4.2.3 OF THE TOWN OF CASTLE ROCK LANDSCAPE AND IRRIGATION PERFORMANCE STANDARDS AND CRITERIA MANUAL FOR IRRIGATION SUBMITTAL AND DESIGN REQUIREMENTS. CHANGES TO THE LANDSCAPE PLAN MAY BE NECESSARY DUE TO CONSTRUCTION DOCUMENTS IRRIGATION PLAN REVIEW COMMENTS.

13. LANDSCAPE AND IRRIGATION SHALL BE INSTALLED BY A TOWN OF CASTLE ROCK REGISTERED LANDSCAPE CONTRACT PROFESSIONAL.

14. DEAD PLANT MATERIALS SHALL BE REMOVED AND REPLACED WITH HEALTHY PLANTING MATERIALS OF COMPARABLE SIZE AND SPECIES THAT MEET THE ORIGINAL INTENT OF THE APPROVED LANDSCAPE DESIGN WITHIN FORTY-FIVE(45) DAYS OR SOONER IN THE EVENT OF A CONTAGIOUS DISEASE OR INVASIVE INSECT SPECIES. TOWN OF CASTLE ROCK IS NOT RESPONSIBLE FOR PLANT REPLACEMENTS.

15. SLOPES STEEPER THAN 3:1 ARE NOT PERMITTED ON LANDSCAPE PLANS IN THE TOWN OF CASTLE ROCK.

OTHER LANDSCAPE NOTES

1. ALL PLANT AREAS SHALL BE MULCHED WITH 4" ORGANIC SHREDDED HARDWOOD MULCH.

2. ALL DISTURBED LANDSCAPED AREAS SHALL BE SEEDED WITH A DROUGHT TOLERANT NATIVE SEED GRASS MIX OR DROUGHT TOLERANT TURF MIX AS RECOMMENDED IN THE TOWN OF CASTLE ROCK RECOMMENDED PLANT LIST. THESE AREAS SHALL RECEIVE INITIAL SPRAY IRRIGATION TO ESTABLISH PLANT MATERIAL AND SHALL DECREASE IRRIGATION VOLUME AND FREQUENCY AS PLANTS BECOME ESTABLISHED.

3. ALL SHRUB, ORNAMENTAL GRASS, PERENNIAL, AND TREE AREAS SHALL BE DRIP IRRIGATED UNLESS OTHERWISE SPECIFIED.


4. CORNELL UNIVERSITY (CU) STRUCTURAL SOIL REQUIRED FOR ALL PLANTING AREAS LESS THAN 8'-0" IN WIDTH.

5. TOTAL MINIMUM IS 4 CU YDS OF ORGANIC MATTER PER 1,000 SF OF LANDSCAPE AREA. THIS IS TO BE ROTOTILLED TO A DEPTH OF 6 INCHES. CLASS I COMPOST IS REQUIRED.


STREETSCAPE

LANDSCAPE REQUIREME	ENTS							
STREET*	LENGTH	UNITS	TREES REQUIRED (1 PER 22'-0")	TREES PROVIDED	SHRUBS REQUIRED (5 PER TREE)	SHRUBS PROVIDED	PERENNIALS REQUIRED (7 PER TREE)	PERENNIALS PROVIDED
WILCOX STREET	326'-0"	LF	15	17	5 TREES X 5 = 25	25	10 TREES X 7 = 70	112
PHELPS STREET	462'-0"	LF	21	20**	11 TREES X 5 = 55	55	10 TREES X 7 = 70	102
		TOTALS	36	37	80	80	140	214


* PERRY STREET NOT PART OF THIS SDP ** VARIANCE FOR MINIMUM REQUIRED STREET TREES APPROVED BY DRB. SEE TCV21-0070.

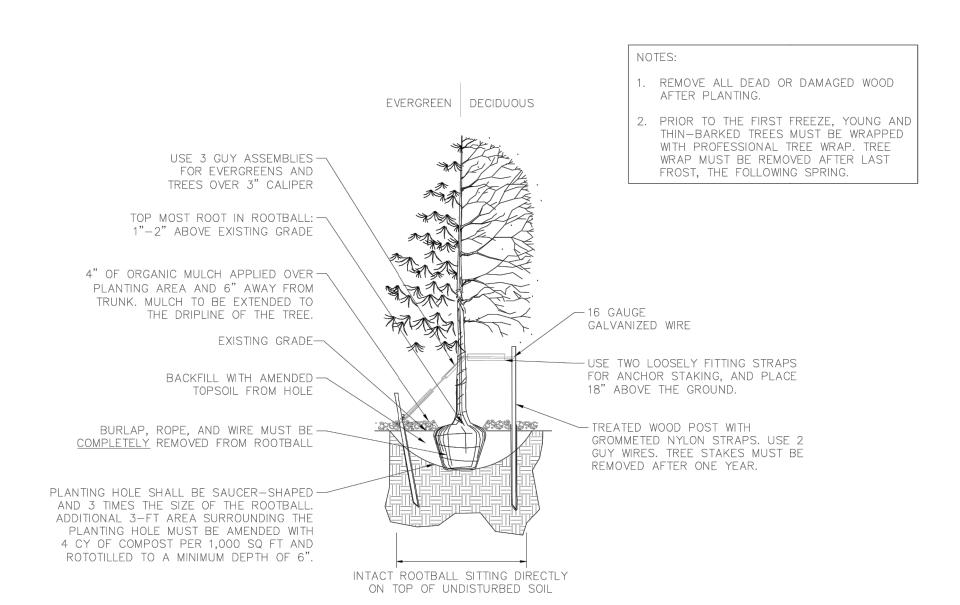

TREE PLANTING

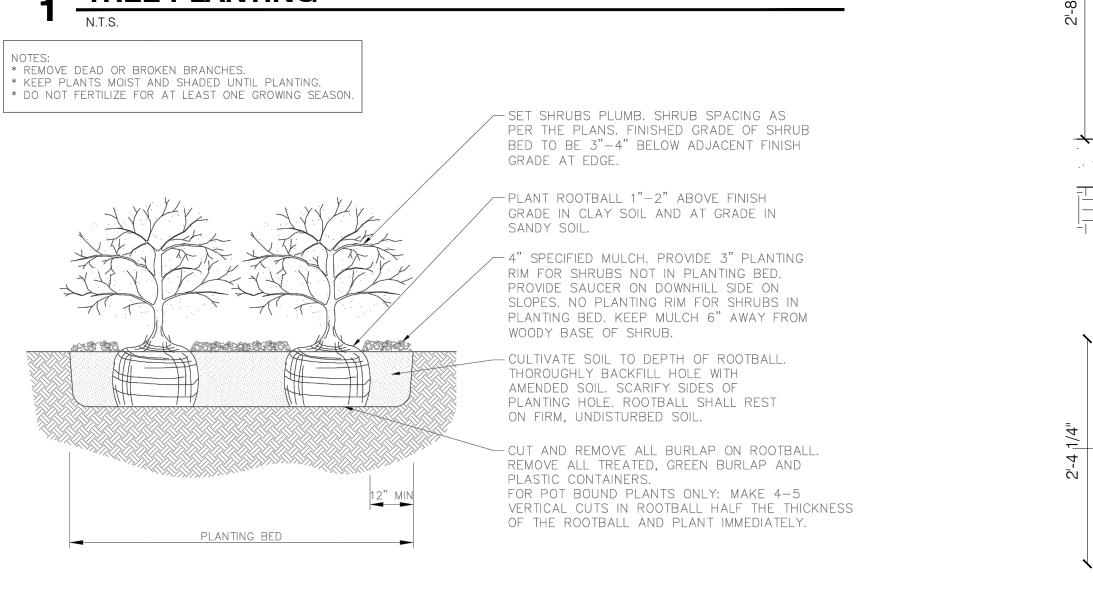

2 SHRUB PLANTING

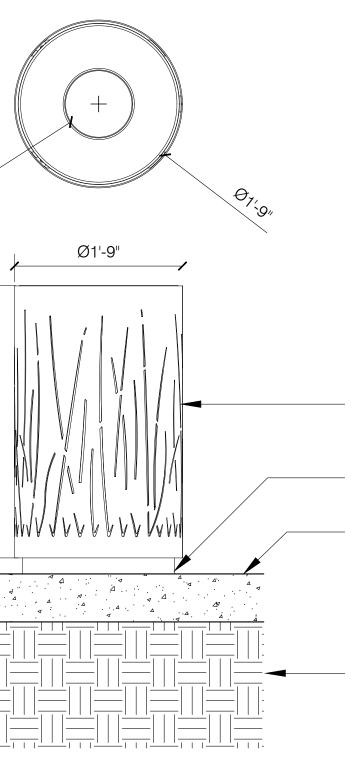


LANDSCAPE FORMS LAKESIDE LITTER RECEPTACLE GRASS PATTERN, TOP OPENING FREE STANDING MOUNTING


CIP CONC PVMT

- COMPACTED SUBGRADE

3 LITTER RECEPTACLE

BIKE RACK

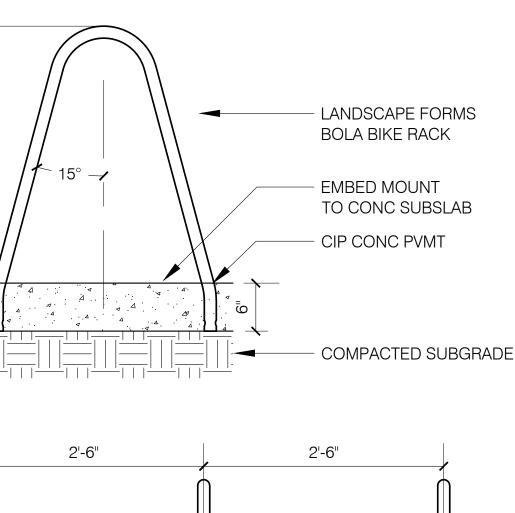

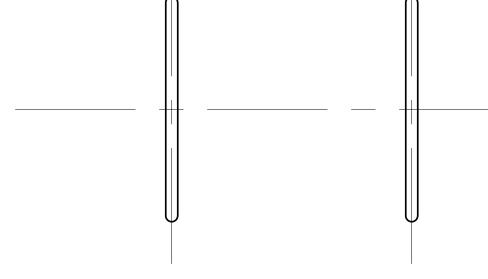



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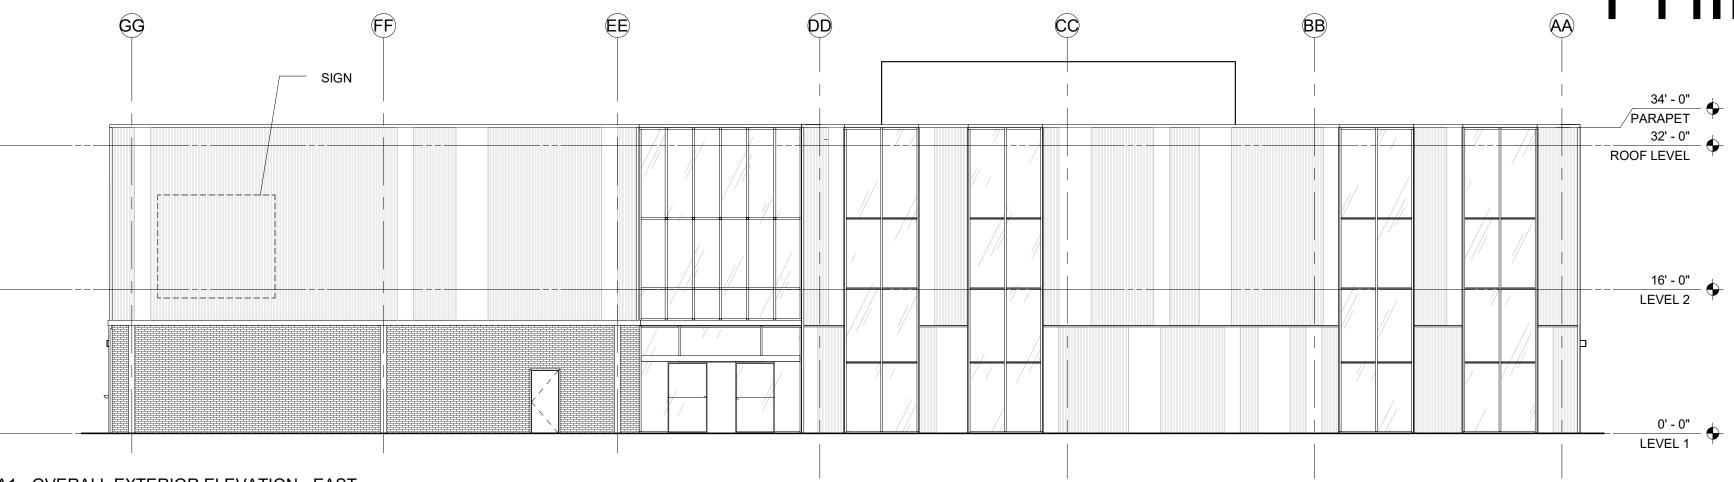
Date

1-SDP21-0042 LANDSCAPE SUMMARY, NOTES, & DETAILS


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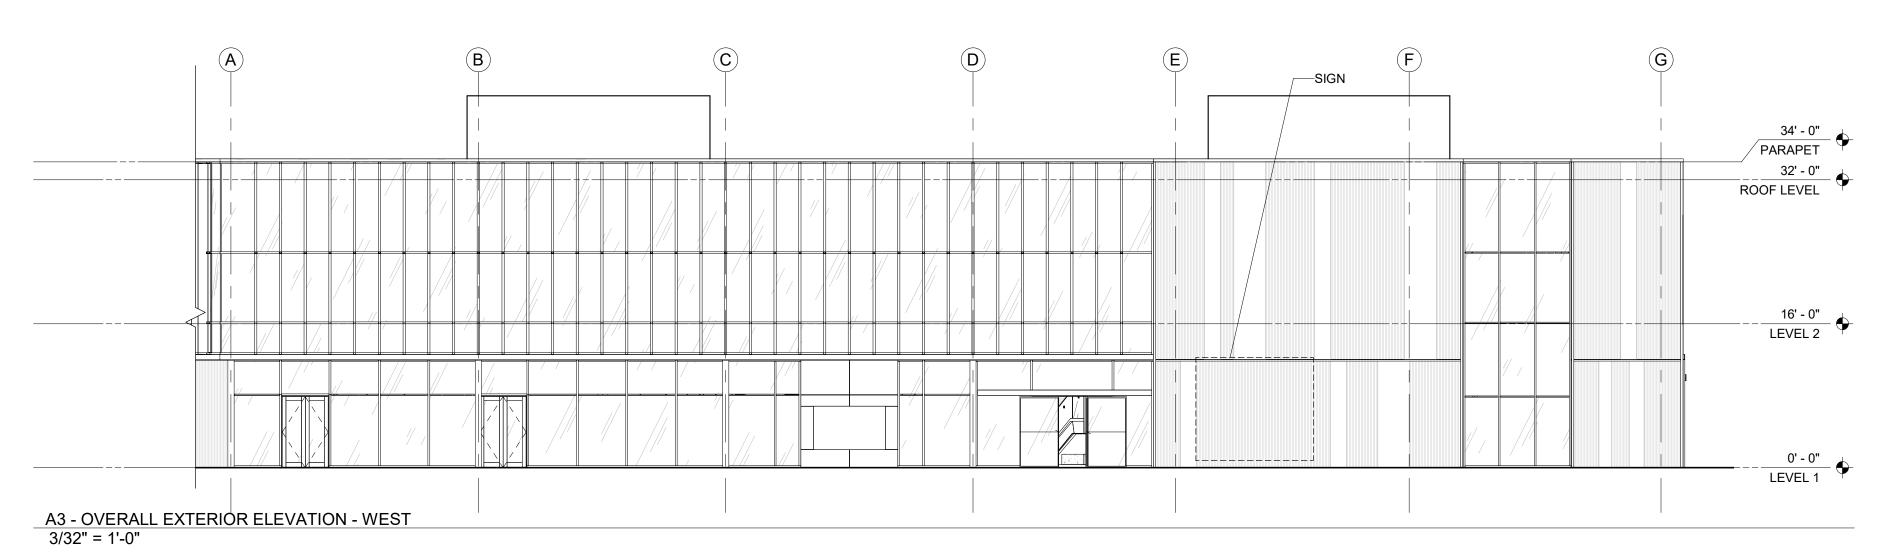
SDP SUBMISSION 5


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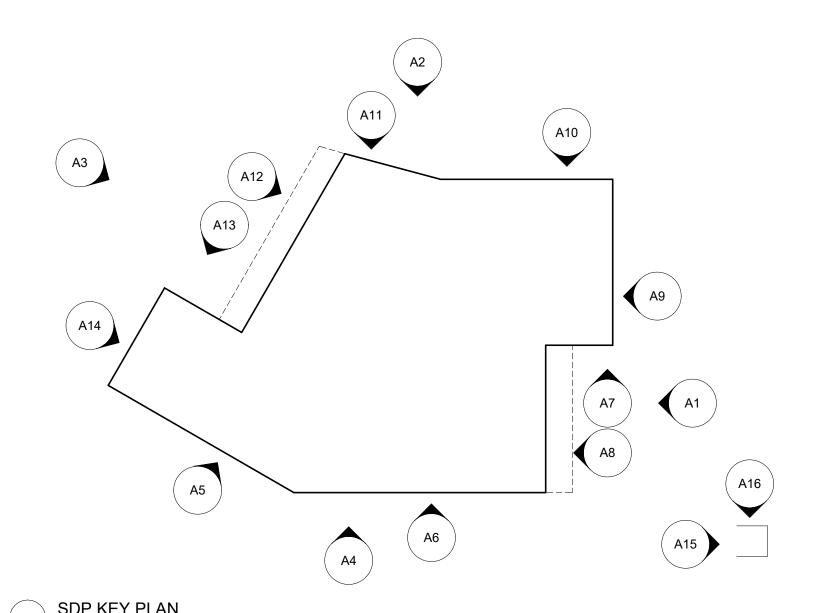





PHILIP S MILLER LIBRARY

BUILDING SIGN NOTE

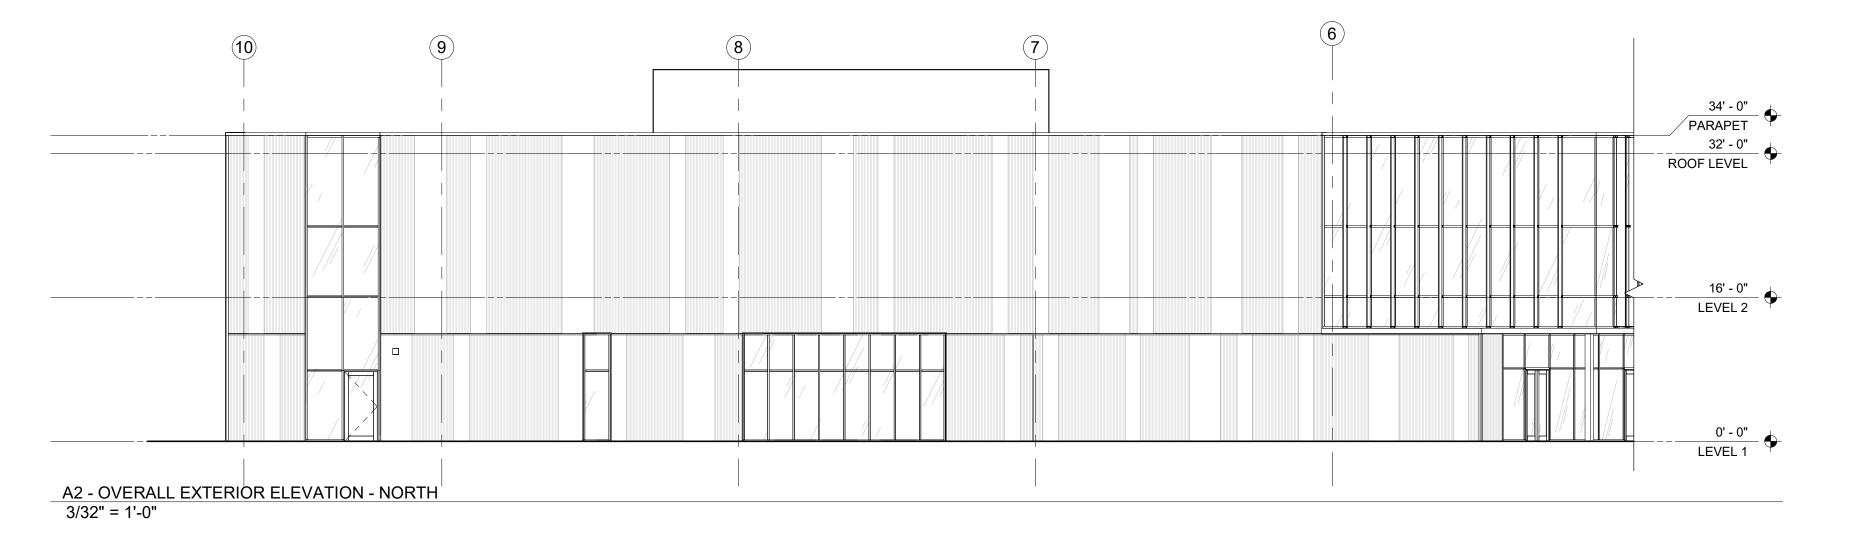All building signs will be reviewed and approved at time of sign permit. All signs to be in conformance with the Town of Castle Rock Sign Code Regulations.

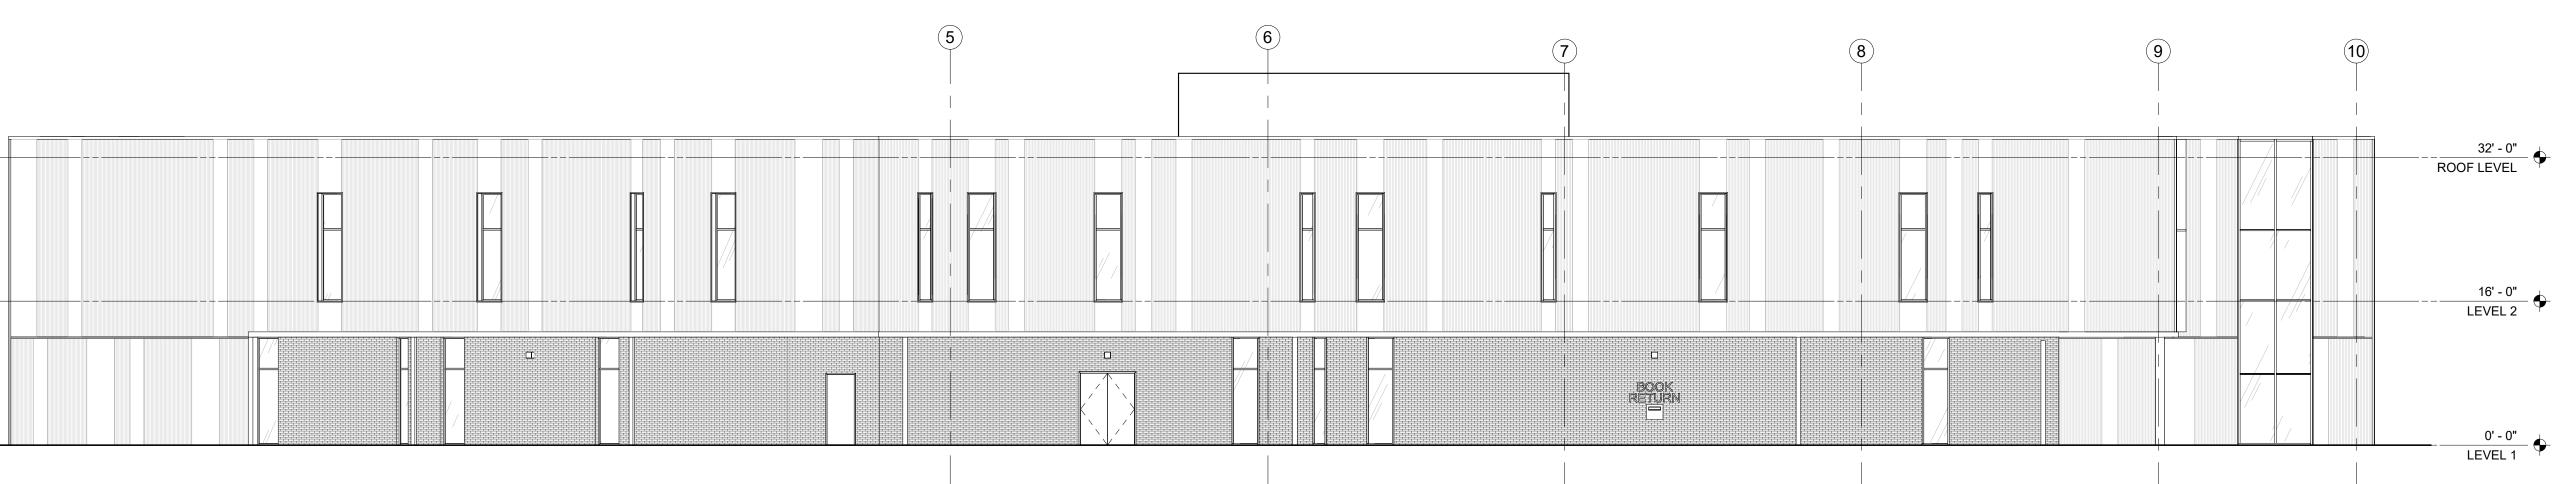

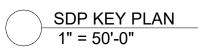

EXTERIOR MATERIALS LEGEND BRICK MASONRY DARK GREY, BROWN MIX FAUX WOOD SOFFIT

WEATHERED STEEL CORRUGATED METAL A WALL PANEL WEATHERED STEEL FLAT METAL WALL В

PANEL

LEGEND - EXTERIOR MATERIALS 1/4" = 1'-0"

Site Development Plan Phillip S Miller Library. Town of Castle Rock Project No. SDP21-0042



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Low Voltage + Technology Consultant

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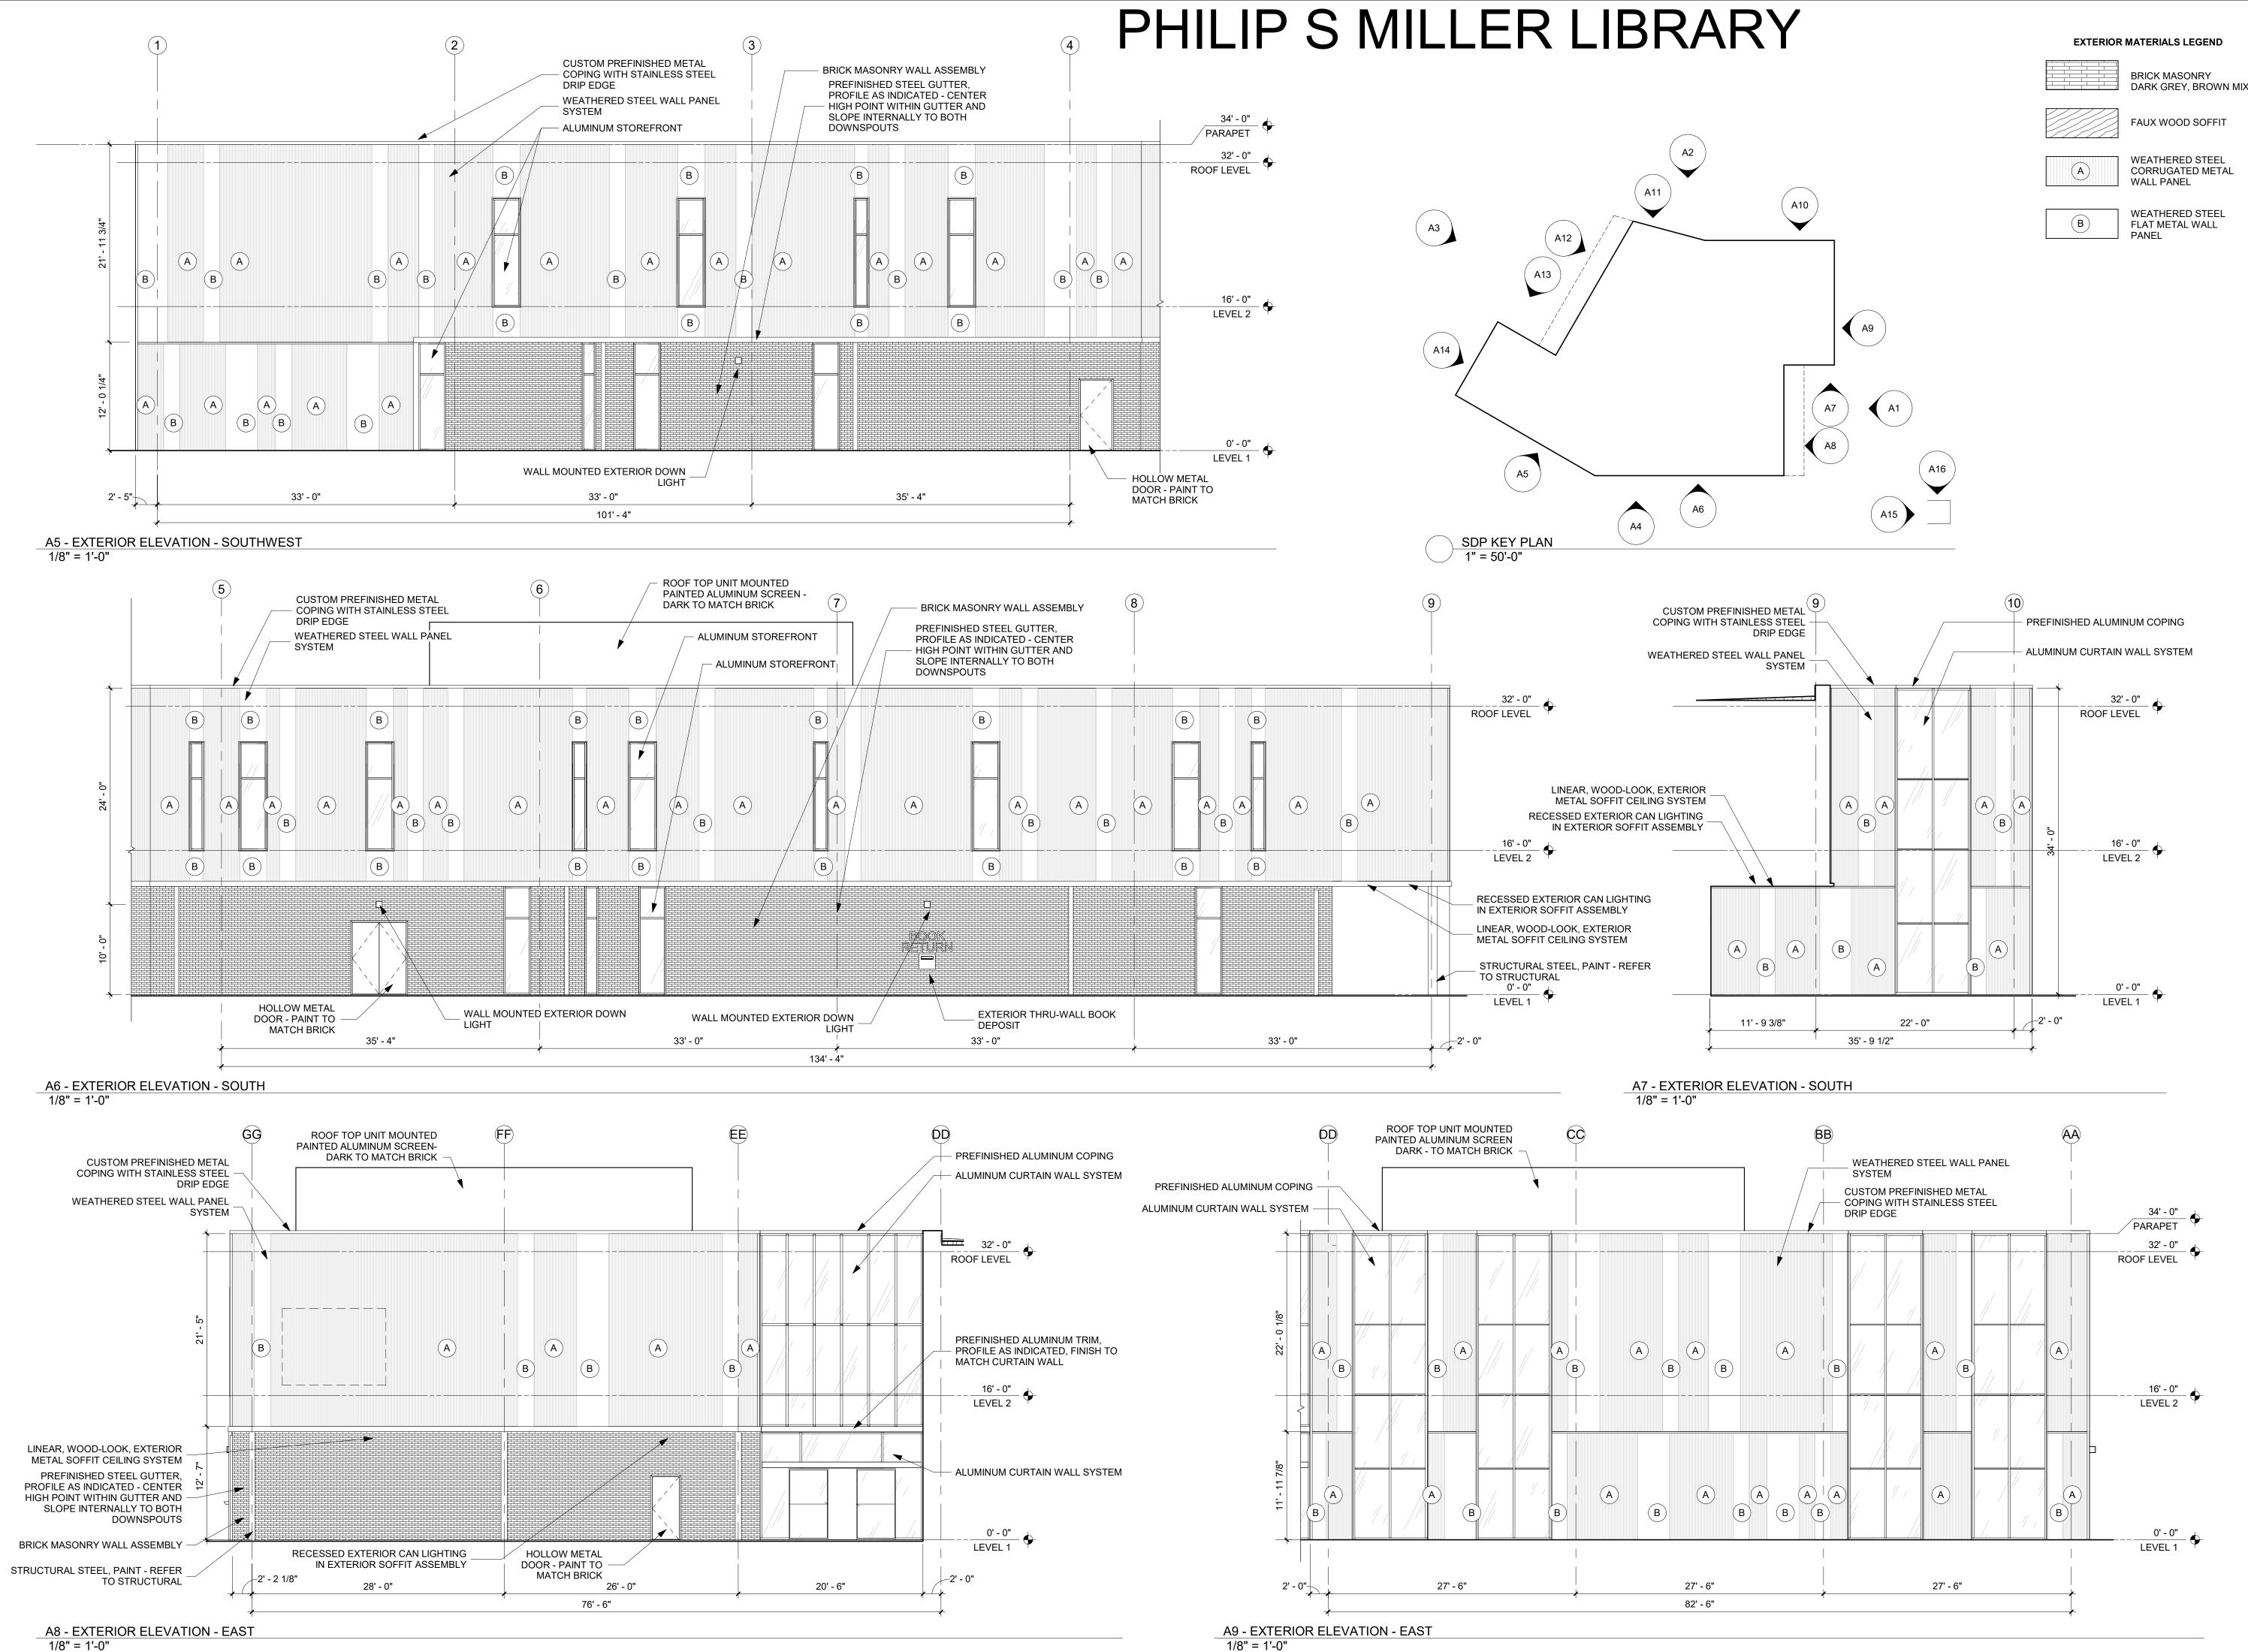
Revision Description

OPN Project No. 21212000 Sheet Issue Date

1/12/2022 SDP SUBMISSION 5

Sheet Name 2-SDP21-0042 BUILDING ELEVATIONS

Sheet Number



A8 - EXTERIOR ELEVATION - EAST 1/8" = 1'-0"





FLAT METAL WALL



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Owner

Douglas County Libraries 100 S. Wilcox St Castle Rock, CO 80104

Project

CASTLE ROCK LIBRARY 100 S. Wilcox St Castle Rock, CO 80104

General Contractor

Fransen Pittman 9563 South Kingston Court Englewood, CO 80112 P. 303-783-3900

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Revision Description

OPN Project No. 21212000 Sheet Issue Date SDP SUBMISSION 5

Sheet Name


1/12/2022

2-SDP21-0042 BUILDING ELEVATIONS

Sheet Number

13 OF 17

Site Development Plan Phillip S Miller Library. Town of Castle Rock Project No. SDP21-0042

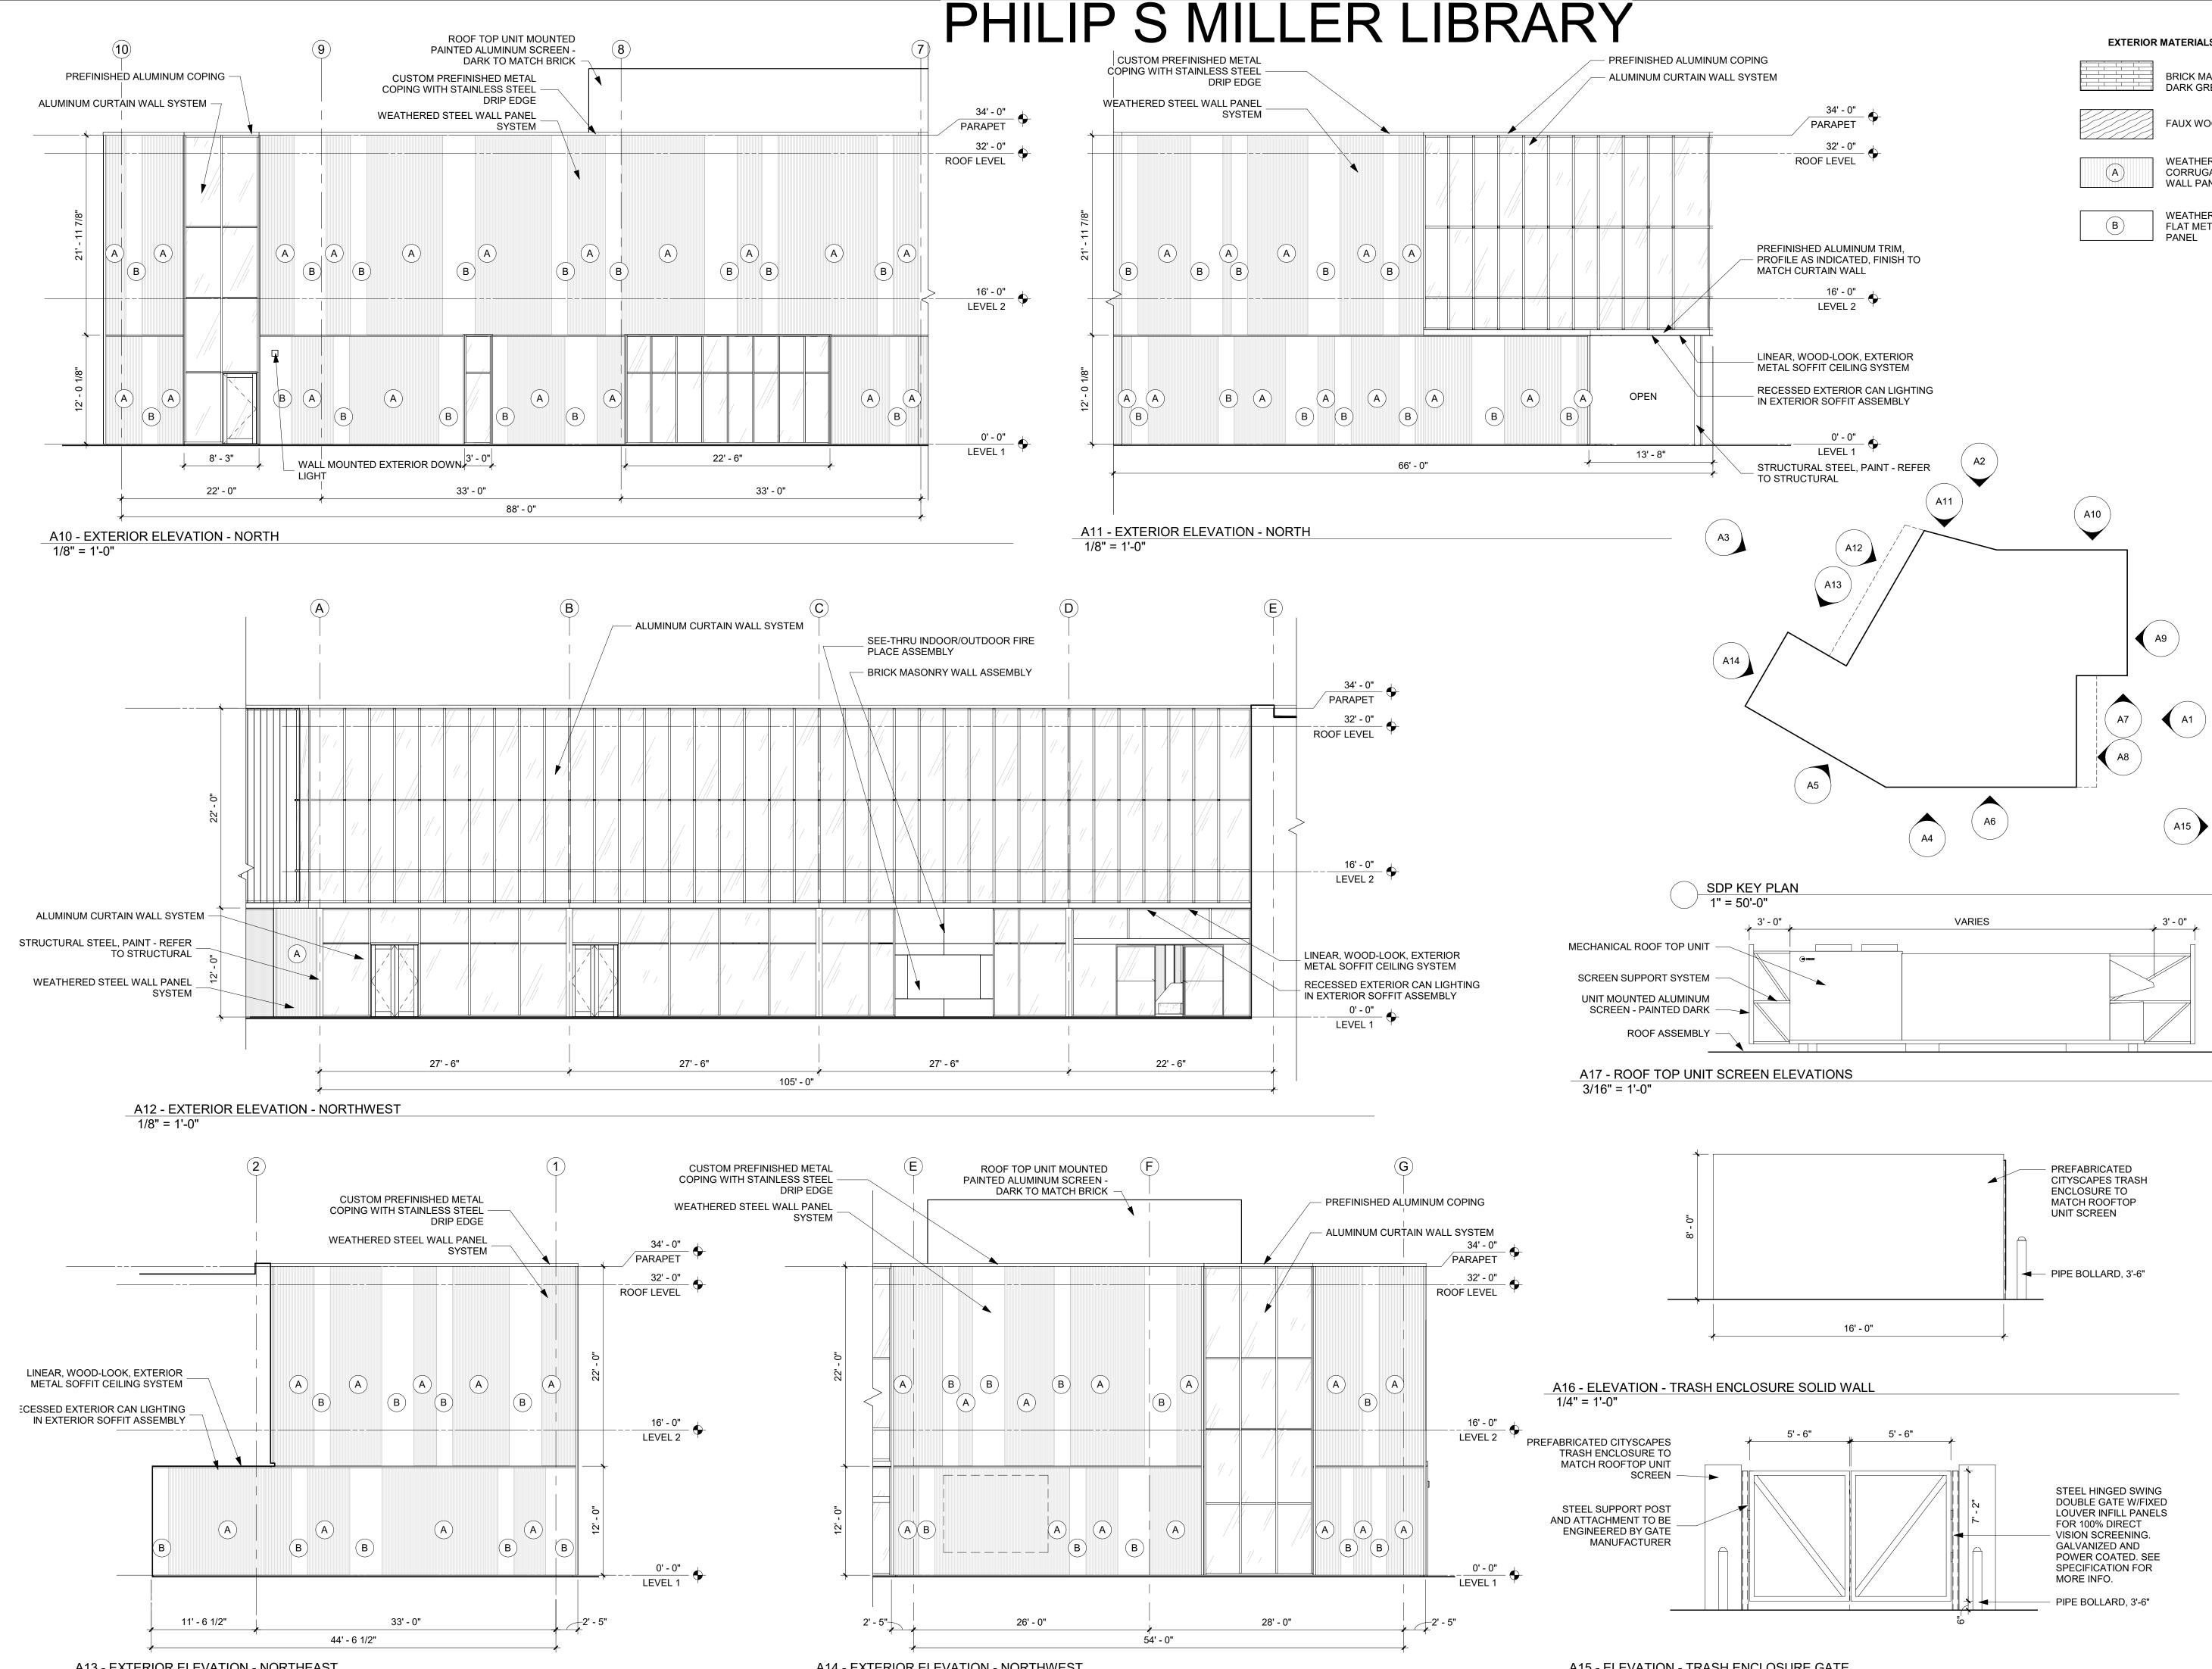

A13 - EXTERIOR ELEVATION - NORTHEAST 1/8" = 1'-0"

A14 - EXTERIOR ELEVATION - NORTHWEST 1/8" = 1'-0"

Site Development Plan Phillip S Miller Library. Town of Castle Rock Project No. SDP21-0042

EXTERIOR MATERIALS LEGEND

BRICK MASONRY DARK GREY, BROWN MIX
FAUX WOOD SOFFIT
WEATHERED STEEL CORRUGATED METAL WALL PANEL

WEATHERED STEEL FLAT METAL WALL PANEL

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A16

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OPN Project No. 21212000

Sheet Issue Date 1/12/2022 SDP SUBMISSION 5 Sheet Name

2-SDP21-0042 BUILDING **ELEVATIONS**

Sheet Number



A15 - ELEVATION - TRASH ENCLOSURE GATE 1/4" = 1'-0"

WEATHERED STEEL CORRUGATED METAL WALL PANEL

LINEAR, WOOD-LOOK, EXTERIOR METAL SOFFIT CEILING

CLEAR ANODIZED ALUMINUM GLAZING SYSTEM

PHILIP S MILLER LIBRARY





WEATHERED STEEL FLAT METAL WALL PANEL



MATERIAL BOARD

Site Development Plan Phillip S Miller Library. Town of Castle Rock Project No. SDP21-0042



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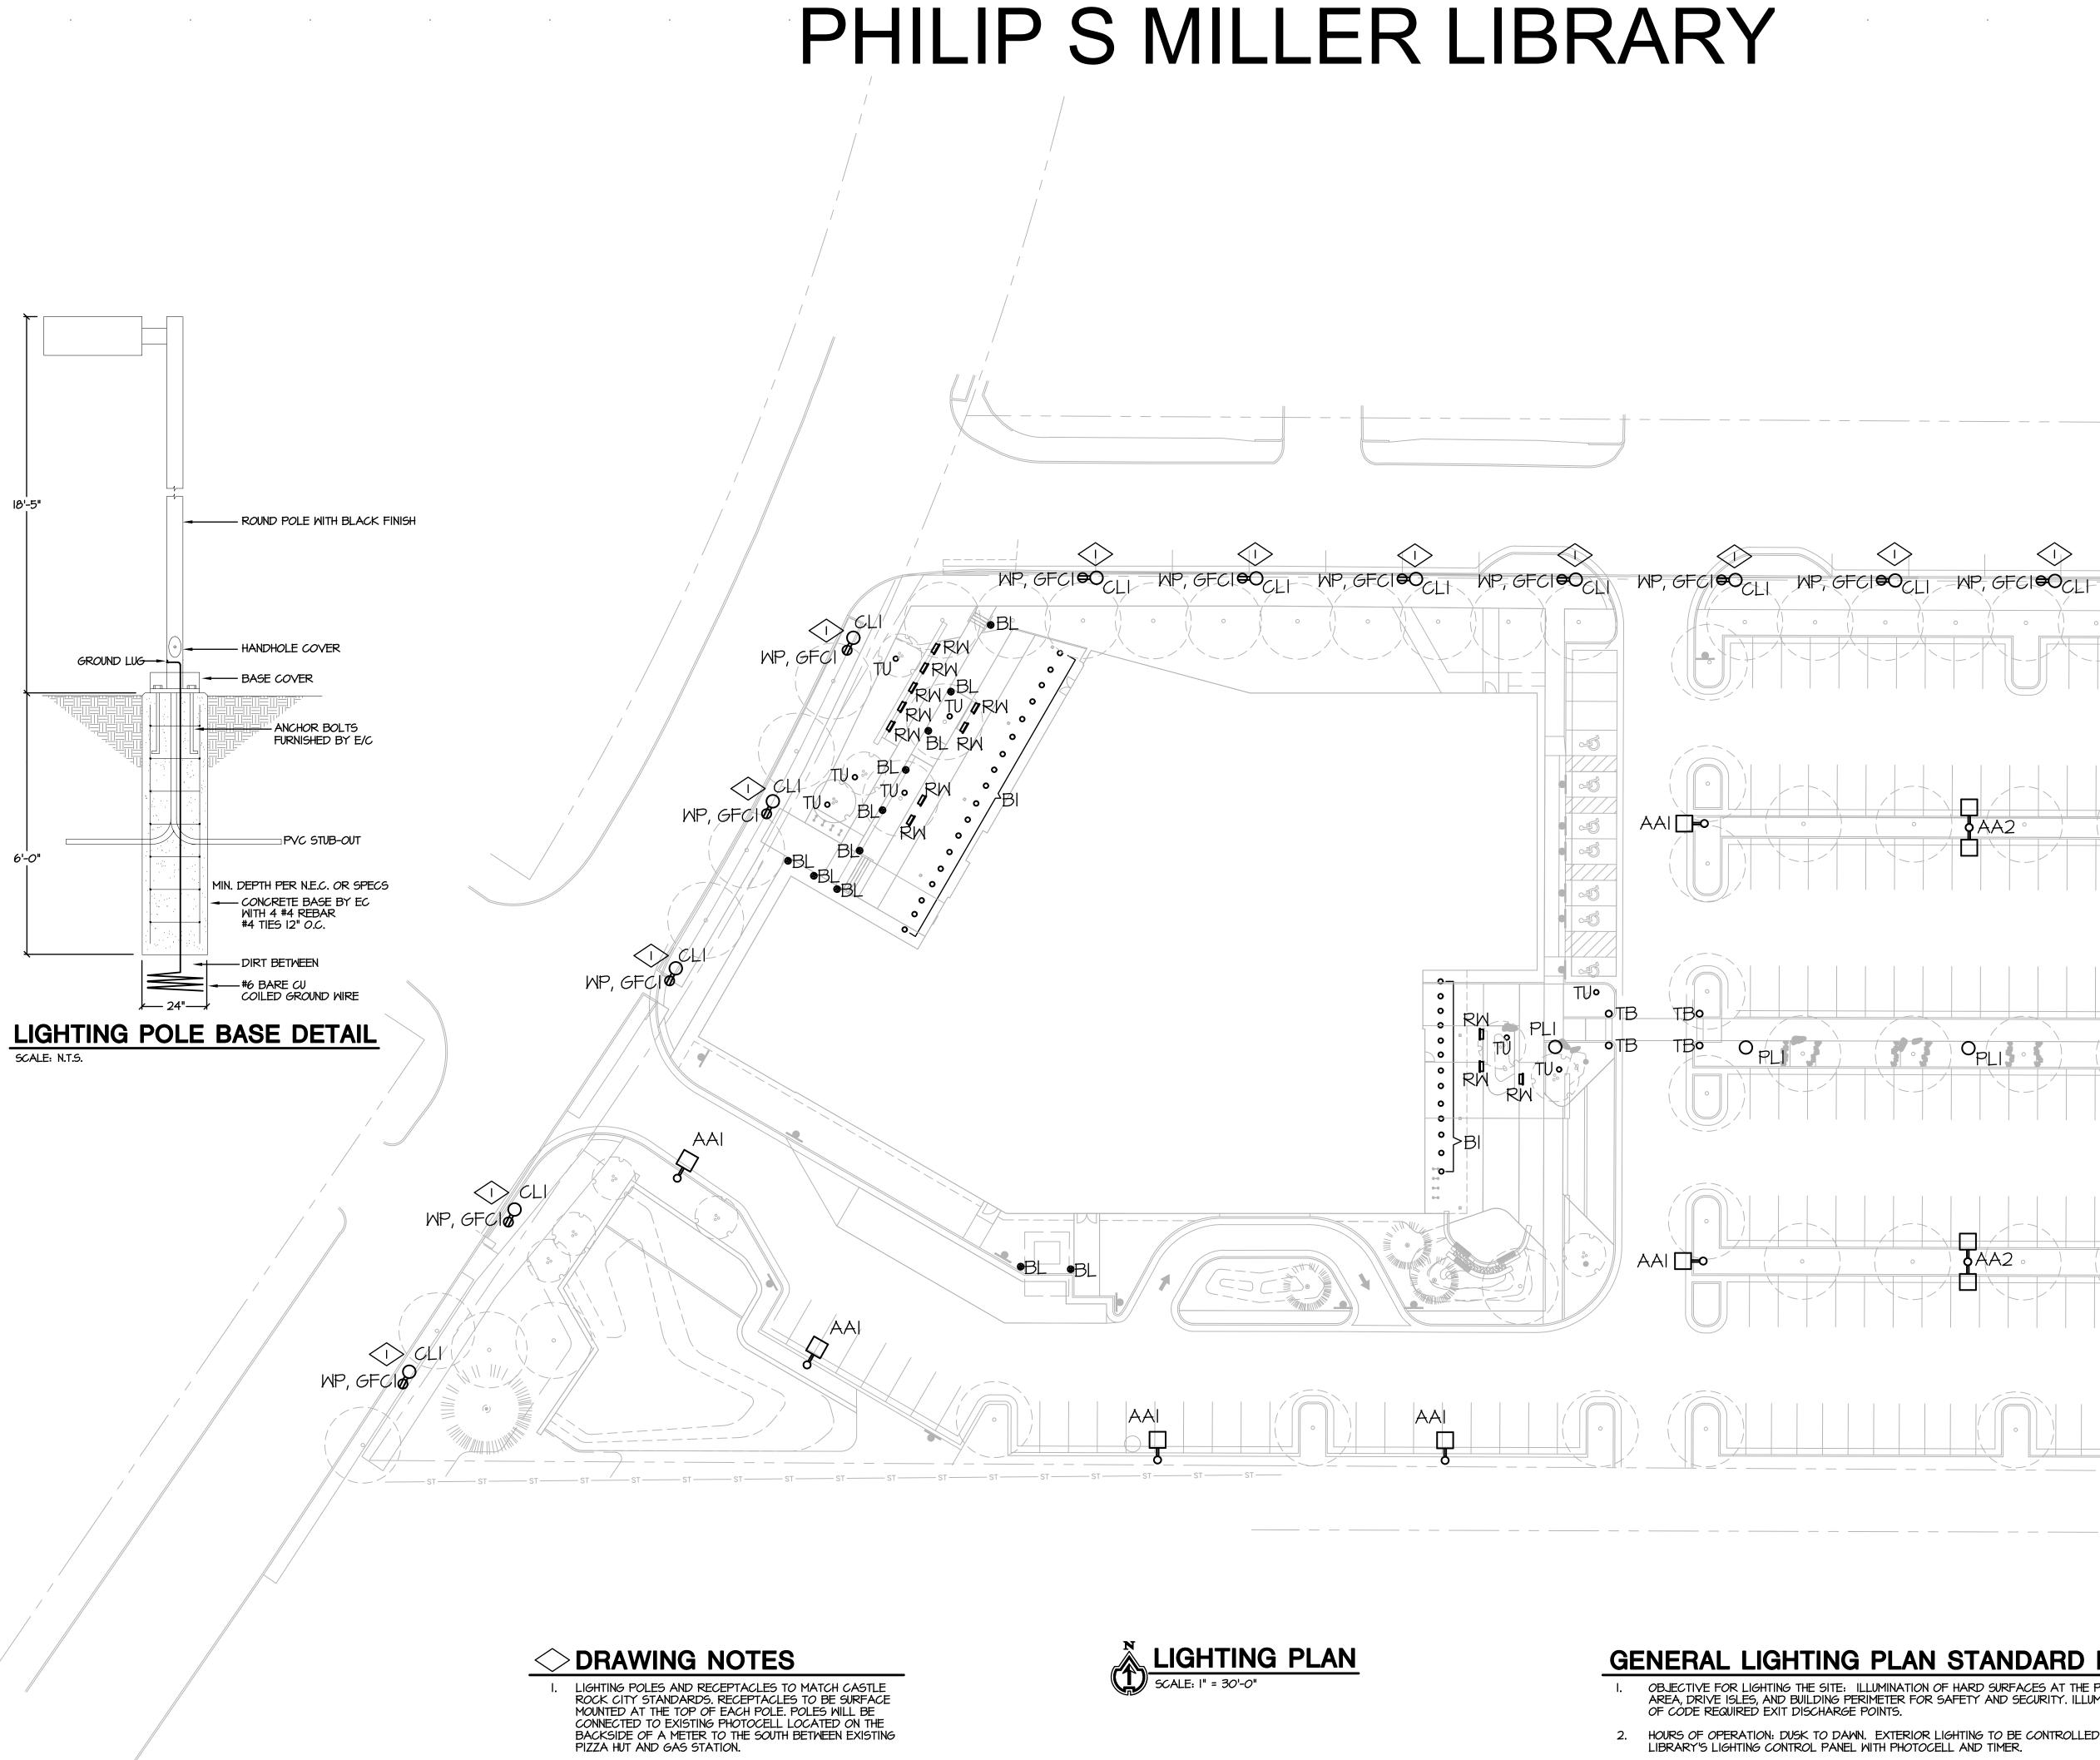
Sheet Number

Sheet Issue Date SDP SUBMISSION 5 Sheet Name

2-SDP21-0042 EXTERIOR MATERIALS

15 of 17

1/12/2022



GENERAL LIGHTING PLAN STANDARD NOTES:

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 $\langle i \rangle$

AA2

- OBJECTIVE FOR LIGHTING THE SITE: ILLUMINATION OF HARD SURFACES AT THE PARKING AREA, DRIVE ISLES, AND BUILDING PERIMETER FOR SAFETY AND SECURITY. ILLUMINATION OF CODE REQUIRED EXIT DISCHARGE POINTS.
- 3.
- 4. WALL PACKS.



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WP, GFCIOCLI WP, GFCIOCLI


2. HOURS OF OPERATION: DUSK TO DAWN. EXTERIOR LIGHTING TO BE CONTROLLED BY LIBRARY'S LIGHTING CONTROL PANEL WITH PHOTOCELL AND TIMER.

MITIGATION TO THE ADJACENT PROPERTIES: FULL CUT-OFF TYPE LIGHTING FIXTURES UTILIZED TO LIMIT GLARE AND LIGHT SPILL BEYOND PROPERTY LINE.

THE FOLLOWING LIGHTING TYPES ARE PROHIBITED: FORWARD THROW (TYPE IV) DISTRIBUTION, POLE-MOUNTED LIGHTS AIMED AT A BUILDING'S FACADE, AND UNSHIELDED


Site Development Plan Phillip S Miller Library. Town of Castle Rock Project No. SDP21-0042

OPN Project No. S21212000 Sheet Issue Date SDP SUBMISSION 5 1/12/2022 Sheet Name 2-SDP-21-0042 LIGHTING PLAN

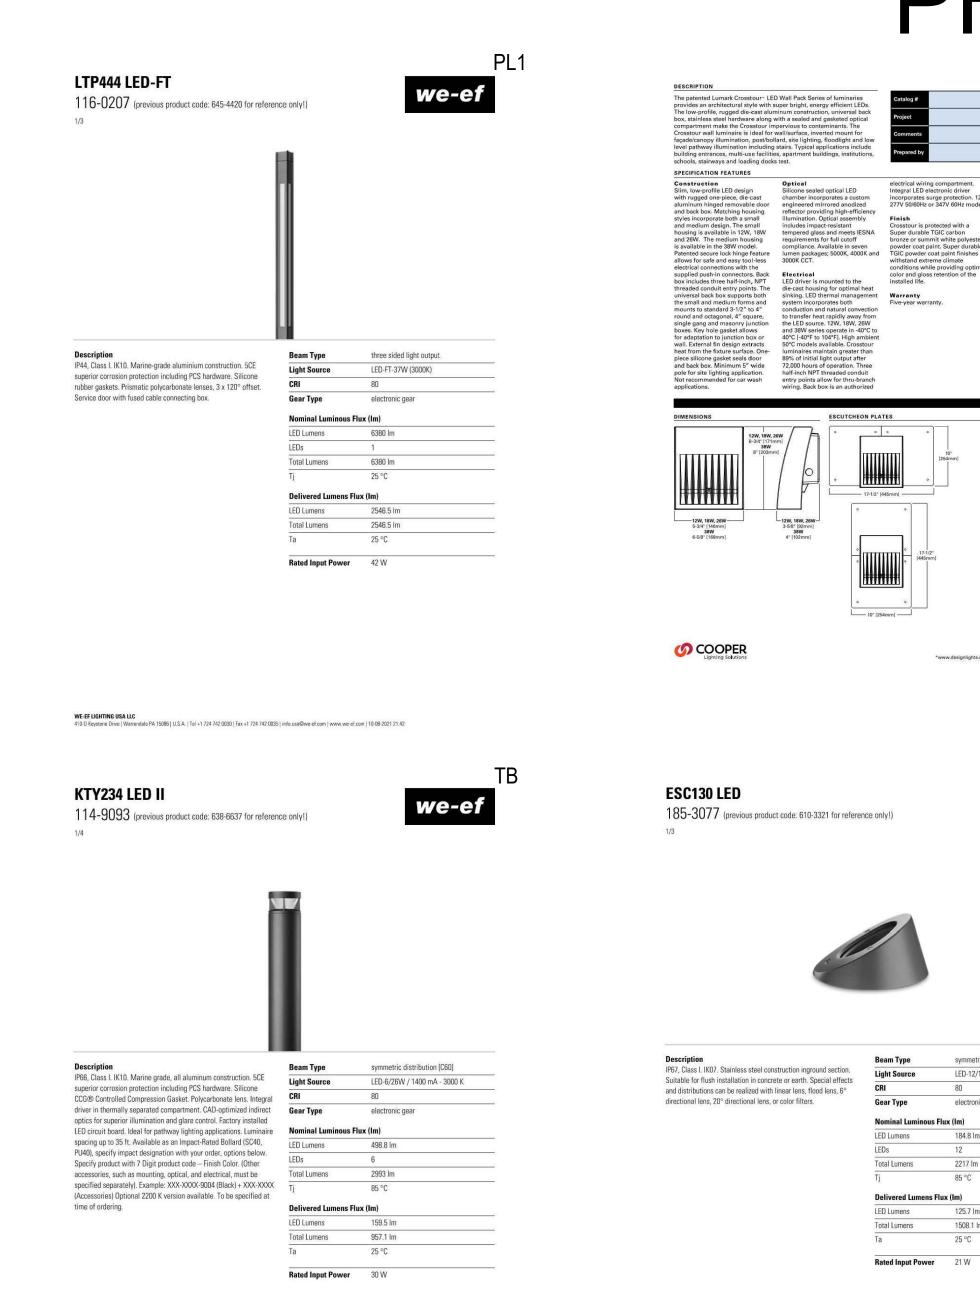

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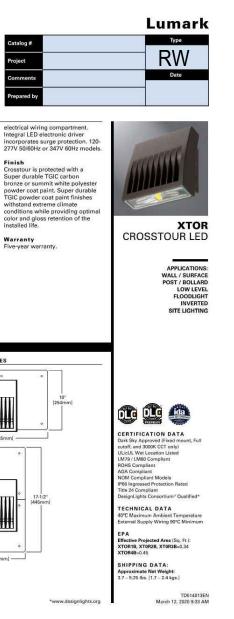
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SternbergLighting

PHILIP S MILLER LIBRARY

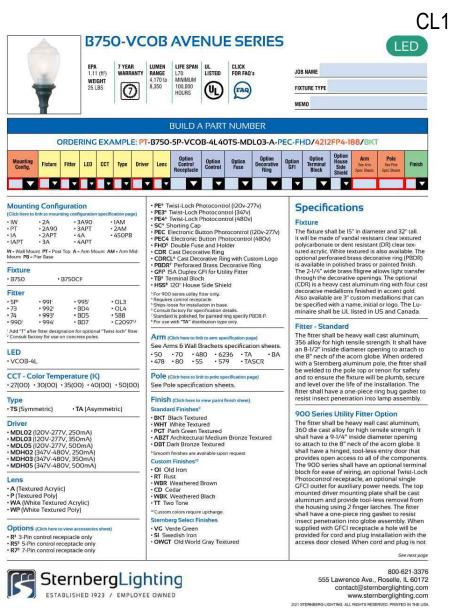

TU we-ef

	symmetric, medium beam [M]
	LED-12/18W / 500 mA - 3000 K
	80
	electronic gear
Flux	(Im)
	184.8 lm
	12
	2217 lm
	85 °C
lux	(Im)
	125.7 lm
	1508.1 lm
	25 °C
	21 W

JMINAIR	MINAIRE						LAMPS POLE										
ID	MANUFACTURER	MODEL	CATALOG NUMBER	DESCRIPTION	DISTRIBUTION	VOLTAGE	DIMMING	QTY.	MOUNTING	QTY.	TYPE	WATTS	LUMENS	COLOR TEMP/CRI	BASE HT.	SHAPE	POLE H
AA1	COOPER LIGHTING	GLEON	GLEON-SA1D-740-U-T3-GM	GALLEON 70 CRI, 4000K MOUNTED LED LUMINAIRE, 18.5 POLE HT, TYPE III DISTRIBUTION, 1 SQUARE, GRAPHITE METALIC FINISH	TYPE III	UNV	0-10V	8	POLE	1	LED	121	8125	4000K/70	FLUSH	RECTANGULAR	18.5'
AA2	COOPER LIGHTING	GLEON	GLEON-SA1D-740-U-T3-GM	GALLEON 70 CRI, 4000K MOUNTED LED LUMINAIRE, 18.5 POLE HT, TYPE III DISTRIBUTION, 1 SQUARE, GRAPHITE METALIC FINISH (TWO HEADS AT 180 DEGREES)	TYPE III	UNV	0-10V	2	POLE	1	LED	242	16250	4000K/80		RECTANGULAR	18.5'
B1	COOPER LIGHTING	HALO PR6	PR6FS24D010	6" LED DOWNLIGHT, FIELD SELECTABLE LUMENS 2000-4000, 0-10V DIMMING	MEDIUM	120V	0-10V	31	RECESSED	1	LED	20.4	2000	3500K/80	-	-	-
BL	WE-EF	PSY414 LED	PSY414-114-0128	MARINE-GRADE ALL ALUMINUM RECTANGULAR BOLLARD LIGHT. 32" HEIGHT WITH GALVANISED STEEL CORE AND CORROSION PROTECTION. RAL9004 BLACK COLOR.	TYPE II	120/277V	0-10V	11	POLE	1	LED	6	738	3000K/80	FLUSH	RECTANGULAR	32"
CL1	STERNBERG	B750-VCOB	PT-B750-5P-VCOB-4L40TS-MCL02-A	TOWN OF CASTLE ROCK STANDARD STREET LIGHT (VERIFY WITH TOWN OF CASTLE ROCK)	SYMMETRIC	120/277V	N/A	14	POLE	1	LED	56	6420	4500K/80	FLUSH	COLUMN	15'
PL1	WE-EF	LTP444 LED-FT	LTP444 LED-FT-116-0207	DIE CAST SLUMINUM COLUMN LIGHT RAL9004 BLACK COLOR. ECG LED DRIVER	C60 SYMMETRIC	120/277V	N/A	3	POLE	1	LED	37	6380	3000K/80	FLUSH	COLUMN	157.48"
RW	COOPER LIGHTING	XTOR CROSSTOUR LED	XTOR1B-W-BK	LOW-PROFILE LED WALL LUMINAIRE 4000K, 12W, BLACK FINISH DARK SKY APPROVED, FULL CUTOFF FIXED MOUNT ON STAIR WALLS	-	120/277V	0-10V	12	WALL (+2'-0")	1	LED	12	1396	4000K/70	-	-	-
ТВ	WE-EF	KTY234 LED II	KTY234 LED II-114-9093	40" MARINE-GRADE ALL ALUMINUM AT 3000K WITH UNIVERSAL VOLTAGE AND DIMMING. 26W BOLLARD FIXTURE	-	UNV	0-10V	4	STEELCORE GROUND FOUNDATION (+31.5" OFF GROUND)	1	LED	26	2993	3000K/80	-	-	-
TU	WE-EF	ESC130 LED	ESC130 LED-185-3077	STAINLESS STEEL INGROUND TREE ILLUMINATION WITH SYMMETRIC MEDIUM BEAM. 18W FIXTURE	-	120V	0-10V	8	INGROUND	1	LED	18	2217	3000K/80	-	-	-



O COOPER

1/3								
Description	Beam Type	rectangular asymmetric Ty						
IP66/IP67. Class I. IK10. Marine-grade, all-aluminium construction.	Light Source	LED-3/6W / 700 mA - 300						
Pole section features galvanised steel reinforcement core. 5CE superior corrosion protection including PCS hardware. Silicone	CRI	80						
CCG® Controlled Compression Gasket. Polycarbonate main lens. Integral EC electronic converter in thermally-separated compartment.	Gear Type	electronic gear						
CAD-optimised optics for superior illumination and glare control	Nominal Luminous Flux (Im)							
OLC® One LED Concept. Factory installed LED circuit board. Pre-	LED Lumens	246 lm						
wired post complete with cable connecting box and fuse for mains connection. Optional 2200 K version up to max. 1050mA available.	LEDs	3						
To be specified at time of ordering.	Total Lumens	738 lm						
	Tj	85 °C						
	Delivered Lumens Flux (Im)							
	LED Lumens	184 lm						
	Total Lumens	552.1 lm						
	Ta	25 °C						
	Rated Input Power	7.7 W						

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PSY414 LED

WE-EF LIGHTING USA LLC

PS500020EN page 1 August 2, 2021 5 15 PM

114-0128 (previous product code: 637-5620 for reference only!)



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Revision Description

OPN Project No. S21212000

Sheet Issue Date SDP SUBMISSION 5

1/12/2022

Sheet Name 2-SDP21-0042 LIGHTING SCHEDULE AND FIXTURE CUTSHEETS

Sheet Number